CONSTRUCTION DRAWINGS for

STUDIO 17 APARTMENTS

LOCATED IN CITY OF WILMINGTON
NEW HANOVER COUNTY, NORTH CAROLINA

GENERAL NOTES:

- 1. NEW HANOVER COUNTY PARCEL NUMBERS: PID = R05407-029-012-000 2. TOTAL PROJECT AREA: 28,125 SF (0.65 AC.)
- 3. EXISTING ZONING DISTRICT: UMX
 4. LAND CLASSIFICATION: URBAN
 5. THIS SITE IS LOCATED WITHIN ZONE "X" ACCORDING TO FEMAFIRM COMMUNITY PANEL NUMBER 37203127003, EFFECTIVE
- DATE 4/3/06
 6. SITE ADDRESS: 514 S. 17TH STREET
 7. EXISTING IMPERVIOUS ONSITE = 11,180 SF
- ASBUILT, BOUNDARY AND TOPOGRAPHIC SURVEY PERFORMED AND PROVIDED TO CSD ENGINEERING BY CAPE FEAR SURVEYING; VERTICAL DATUM = 88
- O. STORMWATER DRAINS TO BURNT MILL CREEK, C.SW 18-74-63-2

WATER & SEWER USAGE NOTES:

CURRENT WATER USAGE 50 GPD CURRENT SEWER USAGE 50 GPD

PROPOSED WATER USAGE 7,730 GPD PROPOSED SEWER USAGE 7,730 GPD

WATER - (32) - 1 BEDROOM X 240 GPD = 7,680 GPD


RETAIL - 2 EMPLOYEES = 50 GPD

SEWER - (32) - 1 BEDROOM X 240 GPD = 7,680 GPD

RETAIL - 2 EMPLOYEES = 50 GPD

	<u>LEGE</u>	<u>ND</u>		
	EXISTING BOUNDARY	w	EXISTING WATERLINE	
	PROPOSED LOTLINE CENTERLINE OF RIGHT OF WAY	— w —	PROPOSED WATERLINE	
29	CONTOUR LINE & ELEVATION		EXISTING / PROPOSED STORM SEWER & CATCH BASIN	
	DRAINAGE FLOW		SEWEN & CATON DASIN	
30'	DRAINAGE EASEMENT	E.I.P.	EXIST. IRON PIPE	
- - 30 - 15'	DRAINAGE EASEMENT		WATER METER SERVICE CONNECTION	
		E.C.M.	EXIST. CONCRETE MONUMENT	
	PROPOSED DRAINAGE PIPE	H	GATE VALVE	
9ss	PROPOSED SANITARY SEWER & MANHOLE	•	REDUCER	
) ——SS	EXISTING SANITARY SEWER & MANHOLE		HANDICAP RAMP	

OWNER: MOSLEY PARK, LLC 1319 MILITARY CUTOFF SUITE CC PMB 172 WILMINGTON, NC 28405

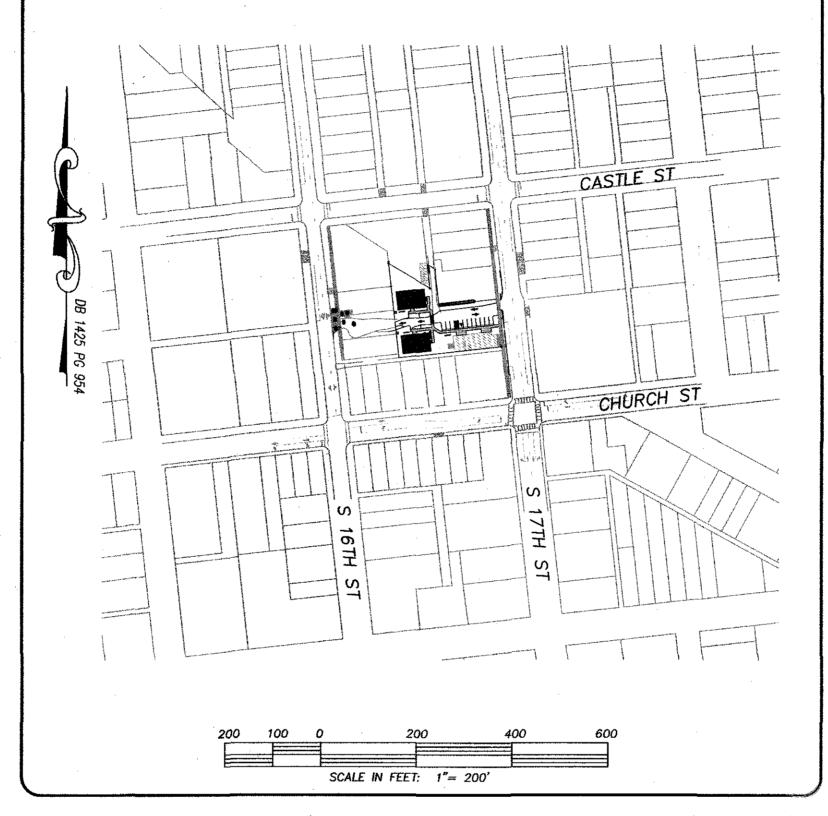

	WA	TER (PUBL	IC)	
SIZE	6"	4"		
TYPE	C-900	C-900		
LF	8	8		
	WA	TER (PRIVA		
SIZE	6"	4"	2"	
TYPE	C-900	C-900	SDR-21	
LF	135	132	235	
		VER (PRIVA	TE)	
SIZE	6"	6"		
TYPE	C-900	DIP		
LF	154	20		

	INDEX TO DRAWINGS	
SHEET No.	DESCRIPTION	DRAWING No.
1 OF 11	COVER SHEET	CD_COVER
2 OF 11	EXISTING BOUNDARY AND TOPOGRAPHY, ADJACENT TRAFFIC	CD_EX-COND
3 OF 11	SITE PLAN	SITE_PLAN
4 OF 11	CITY OF WILMINGTON CONSTRUCTION DETAILS	SP_DET-1
5 OF 11	CITY OF WILMINGTON CONSTRUCTION DETAILS	SP_DET-2
6 OF 11	UTILITY PLAN	UP
7 OF 11	GRADING PLAN	GRADING
8 OF 11	CFPUA STANDARD WATER DETAILS	WSD-1
9 OF 11	CFPUA STANDARD WATER DETAILS	WSD-2
10 OF 11	CFPUA STANDARD SEWER DETAILS	SSD-1
11 OF 11	CFPUA STANDARD SEWER DETAILS	SSD-2
LP1 OF LP1	LANDSCAPING PLAN	LP
1 OF 3	NCDOT ENCROACHMENT PLAN	DOT_ENCR
2 OF 3	NCDOT TRAFFIC CONTROL PLAN	DOT_TCP
3 OF 3	NCDOT STANDARD DETAILS	DOT_DET

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For each open utility cut of City streets, a \$325 permit shall be required from the City prior to occupancy and/or project acceptance.

Approved Construction Plan

Name ______ Date

Planning MC 9 12010

Traffic W SALLS 86-18

Fire Juny MA 8-6-18 Sig

Public Services Engineering Division
APPROVED DRAINAGE PLAN
Date: 08/06/2018 Permit # 2018 033
Signed: Task Ballar for RAC

NOTES:

- ASBUILT, BOUNDARY AND TOPOGRAPHIC SURVEY PERFORMED AND PROVIDED TO CSD ENGINEERING BY CAPE FEAR SURVEYING: 1 NORTH 6TH STREET WILMINGTON, NC 28401, 910-762-9496 FIRM #C-3199
 THIS MAP IS NOT FOR CONVEYANCE, RECORDATION, OR SALES.
- 3. THIS PROPERTY IS LOCATED WITHIN ZONE. "X"

 ACCORDING TO THE FEMA FLOOD INSURANCE RATE MAP,

 3720312700J, EFFECTIVE DATE 4/3/06
- 4. THIS PROPERTY IS ZONED UMX
- CFPUA WATER
 CFPUA SEWER
- 7. ALL CONSTRUCTION TO CONFORM TO NEW HANOVER COUNTY STANDARDS AND APPLICABLE STATE & LOCAL CODES.
- 8. CONTRACTOR TO COORDINATE ANY REQUIRED TRAFFIC CONTROL WITH CITY OF WILMINGTON AND OR NCDOT.
- 9. CARE SHALL BE TAKEN DURING FINAL GRADING TO ENSURE POSITIVE DRAINAGE AWAY FROM BUILDINGS AND TO RECEIVING STRUCTURES.
 ROOF DRAIN DOWNSPOUTS TO BE CONNECTED TO STORM DRAINAGE
- STUBOUTS OR DIRECTED TO STREET/PARKING AREAS.

 10. CONTRACTOR IS RESPONSIBLE FOR COORDINATION OF ANY RELOCATIONS, RE-ALIGNMENTS, DISCONNECTIONS OR CONNECTIONS OF EXISTING UTILITIES WITH APPLICABLE AUTHORITIES.
- 11. CLEARING AND GRUBBING OF SITE TO INCLUDE REMOVAL OF EXISTING CURB, ASPHALT, INLETS, AND ANY OTHER STRUCTURES INCLUDING TREES, STUMPS AND DEBRIS EXISTING ON SITE. TREES NOT REQUIRED TO BE CLEARED FOR CONSTRUCTION SHALL REMAIN UNLESS OTHERWISE DIRECTED.
- 12. INFORMATION CONCERNING UNDERGROUND UTILITIES WAS OBTAINED FROM AVAILABLE RECORDS. IT SHALL BE THE RESPONSIBILITY OF THE CONTRACTOR TO DETERMINE THE EXACT ELEVATIONS AND LOCATIONS OF ALL EXISTING UTILITIES AT ALL CROSSINGS PRIOR TO COMMENCING TRENCH EXCAVATION. IF ACTUAL CLEARANCES ARE LESS THAN INDICATED ON PLAN, THE CONTRACTOR SHALL CONTACT THE DESIGN ENGINEER BEFORE PROCEEDING WITH CONSTRUCTION. ANY CONDITION DISCOVERED OR EXISTING THAT WOULD NECESSITATE A MODIFICATION OF THESE PLANS SHALL BE BROUGHT TO THE ATTENTION OF THE DESIGN ENGINEER BEFORE PROCEEDING WITH CONSTRUCTION.
- 13. NO CONSTRUCTION IS TO BEGIN BEFORE LOCATION OF EXISTING
 UTILITIES HAS BEEN DETERMINED. CALL "NC ONE—CALL" AT LEAST
 48 HOURS BEFORE COMMENCING CONSTRUCTION.
- 14. CONTRACTOR SHALL ADJUST ALL MANHOLES, VALVE & CURB BOXES TO FINAL GRADE UPON COMPLETION OF ALL CONSTRUCTION. ANY BOXES DAMAGED OR OTHERWISE DISTURBED BY THE CONTRACTOR SHALL BE REPAIRED AT THE EXPENSE OF THE CONTRACTOR.
- 15. THE CONTRACTOR IS RESPONSIBLE FOR CONTROLLING DUST AND EROSION DURING CONSTRUCTION AT HIS EXPENSE. PARKING AREAS SHALL BE WATERED TO CONTROL DUST WHEN ORDERED BY THE ENGINEER.
- 16. NO GEOTECHNICAL TESTING HAS BEEN PERFORMED ON SITE. NO
 WARRANTY IS MADE FOR SUITABILITY OF SUBGRADE, AND UNDERCUT
 AND ANY REQUIRED REPLACEMENT WITH SUITABLE MATERIAL SHALL
- BE THE RESPONSIBILITY OF THE CONTRACTOR.

 17. CONTRACTOR TO ENSURE THAT PAVEMENT IS PLACED SO AS TO DRAIN
 POSITIVELY TO THE STREET INLETS AND CATCH BASINS. ALL FUTURE ROOF
 DRAIN DOWNSPOUTS TO BE DIRECTED TO THE STORM DRAINAGE STUBOUTS.
- CONTRACTOR IS RESPONSIBLE FOR OBTAINING ALL REQUIRED PERMITS.
 THIS PLAN IS FOR SITE GRADING, UTILITIES, SITING, AND DRAINAGE ONLY.
 SEE BUILDING PLANS FOR DETAILED HOOKUPS TO BUILDINGS, ETC.
- 20. CONTRACTOR AND BUILDER ARE RESPONSIBLE FOR COORDINATING
 FINISHED FLOOR ELEVATION OF ALL BUILDINGS WITH THE OWNER. ELEVATIONS
 GIVEN ARE MINIMUM GROUND ELEVATIONS AT THE BUILDING SITE AND DO NOT
 PURPORT TO BE FINISHED FLOOR. MINIMUM RECOMMENDED FF ELEVATIONS
- 21. AFFECTED NON-MUNICIPAL UTILITIES SHALL BE CONTACTED AND PROVIDED WITH PLANS AND OTHER PERTINENT INFORMATION, WHEN FEASIBLE, TO COORDINATE APPROPRIATE SCHEDULING AND PLACEMENT.
- 22. EXTREME CARE SHALL BE TAKEN TO ENSURE MINIMUM SEPARATIONS AT ALL UTILITY CROSSINGS.

 23. MINIMUM SEPARATION SHALL BE MAINTAINED AS FOLLOWS:
- a. HORIZONTAL SEPARATION OF 10 FEET BETWEEN SANITARY SEWER AND WATER MAINS AND STORM SEWER.
 b. WHERE VERTICAL CLEARANCE IS LESS THAN 24" BETWEEN SANITARY
- 5. WHERE VERTICAL CLEARANCE IS LESS THAN 24 BETWEEN SANITARY
 SEWER AND WATER OR WHERE SEWER LINE CROSSES ABOVE WATER
 MAIN, BOTH PIPES SHALL BE DUCTILE IRON PIPE FOR A MINIMUM
 OF 10' EITHER SIDE OF CROSSING.
- c. WHERE VERTICAL CLEARANCE IS LESS THAN 24" BETWEEN SANITARY SEWER AND STORM DRAIN, SANITARY SEWER SHALL BE DUCTILE IRON PIPE FOR A MINIMUM OF 10 FEET EITHER SIDE OF CROSSING.
- d. WHERE VERTICAL CLEARANCE IS LESS THAN 12" BETWEEN SANITARY
 SEWER AND STORM DRAIN, SANITARY SEWER SHALL BE DUCTILE IRON
 PIPE FOR A MINIMUM OF 10' EITHER SIDE OF CROSSING, AND BRIDGING
 SHALL BE INSTALLED PER APPLICABLE UTILITY AUTHORITY'S DETAILS.
- e. IN NO CASE SHALL THERE BE LESS THAN 18" OF SEPARATION BETWEEN OUTSIDE OF WATER MAIN AND OUTSIDE OF SEWER OR STORM DRAINAGE.

 f. MINIMUM COVER OF 36" SHALL BE PROVIDED FOR ALL BURIED WATER MAINS AND SANITARY SEWER MAINS.
- 24. SEE DETAIL SHEETS FOR TYPICAL UTILITIES HOOKUPS.
- 25. ALL SANITARY SEWER MAINS TO BE 8" UNLESS OTHERWISE INDICATED.
- 26. ALL WATER MAINS TO BE 8" UNLESS OTHERWISE INDICATED.
- 27. TWO VALVES ARE REQUIRED AT "T" INTERSECTIONS AND ONE VALVE ON THE WATER LINE TO FIRE HYDRANTS.
- 28. A BLOW-OFF VALVE IS REQUIRED AT THE TERMINUS OF ALL "DEAD END" WATER LINES.

(S) CSD

ENGINEERING

LICENSE # C-2710

LAND PLANNING
COMMERCIAL / RESIDENTIAL
P.O. BOX 4041

ENGINEERING


P.O. BOX 4041 WILMINGTON, NC 28406 (910) 791—4441

STUDIO 17 APARTMENTS

STUDIO 17 APARTMENTS

STUDIO 17 APARTMENTS

TED IN CITY OF WILMINGTON
HANOVER COUNTY, NORTH CAROLINA
IER: MOSLEY PARK, LLC
1319 MILITARY CUTOFF
SUITE CC PMB 172

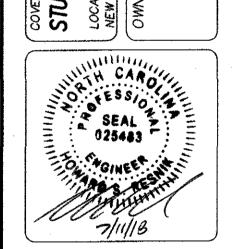

		8WN	BW	#TB	#T#	BY
		REVISED SEWER MAIN TABLES	REVISED WATER MAIN TABLES	REVISED PER TRC COMMENTS	REVISED PER TRC COMMENTS	REMARKS
		*	3	2	•	REV. NO.
) A 7	<i>E:</i>	 2	22-	-18	}	

PROJECT NO.: 17-0434


Sheet No. ____ of ___ 11


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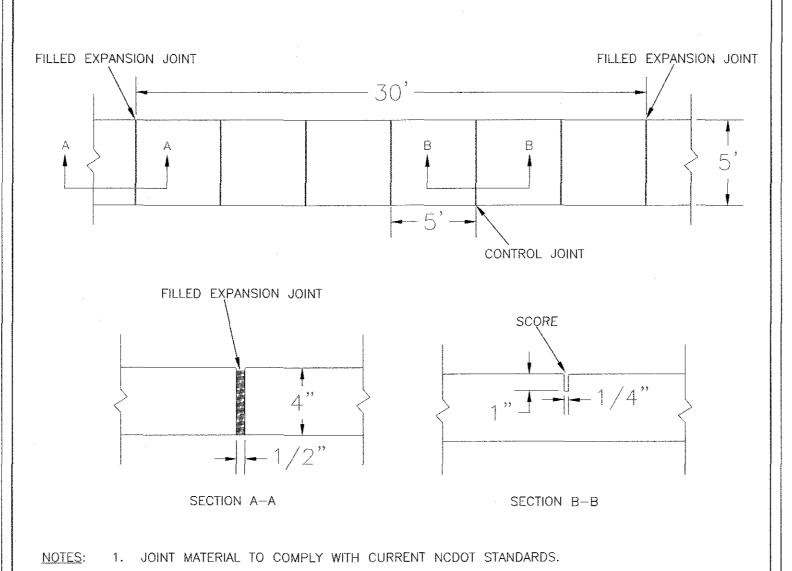
DRAWN BY: MRB

CHECKED BY: HSR

VERT. SCALE: N/A




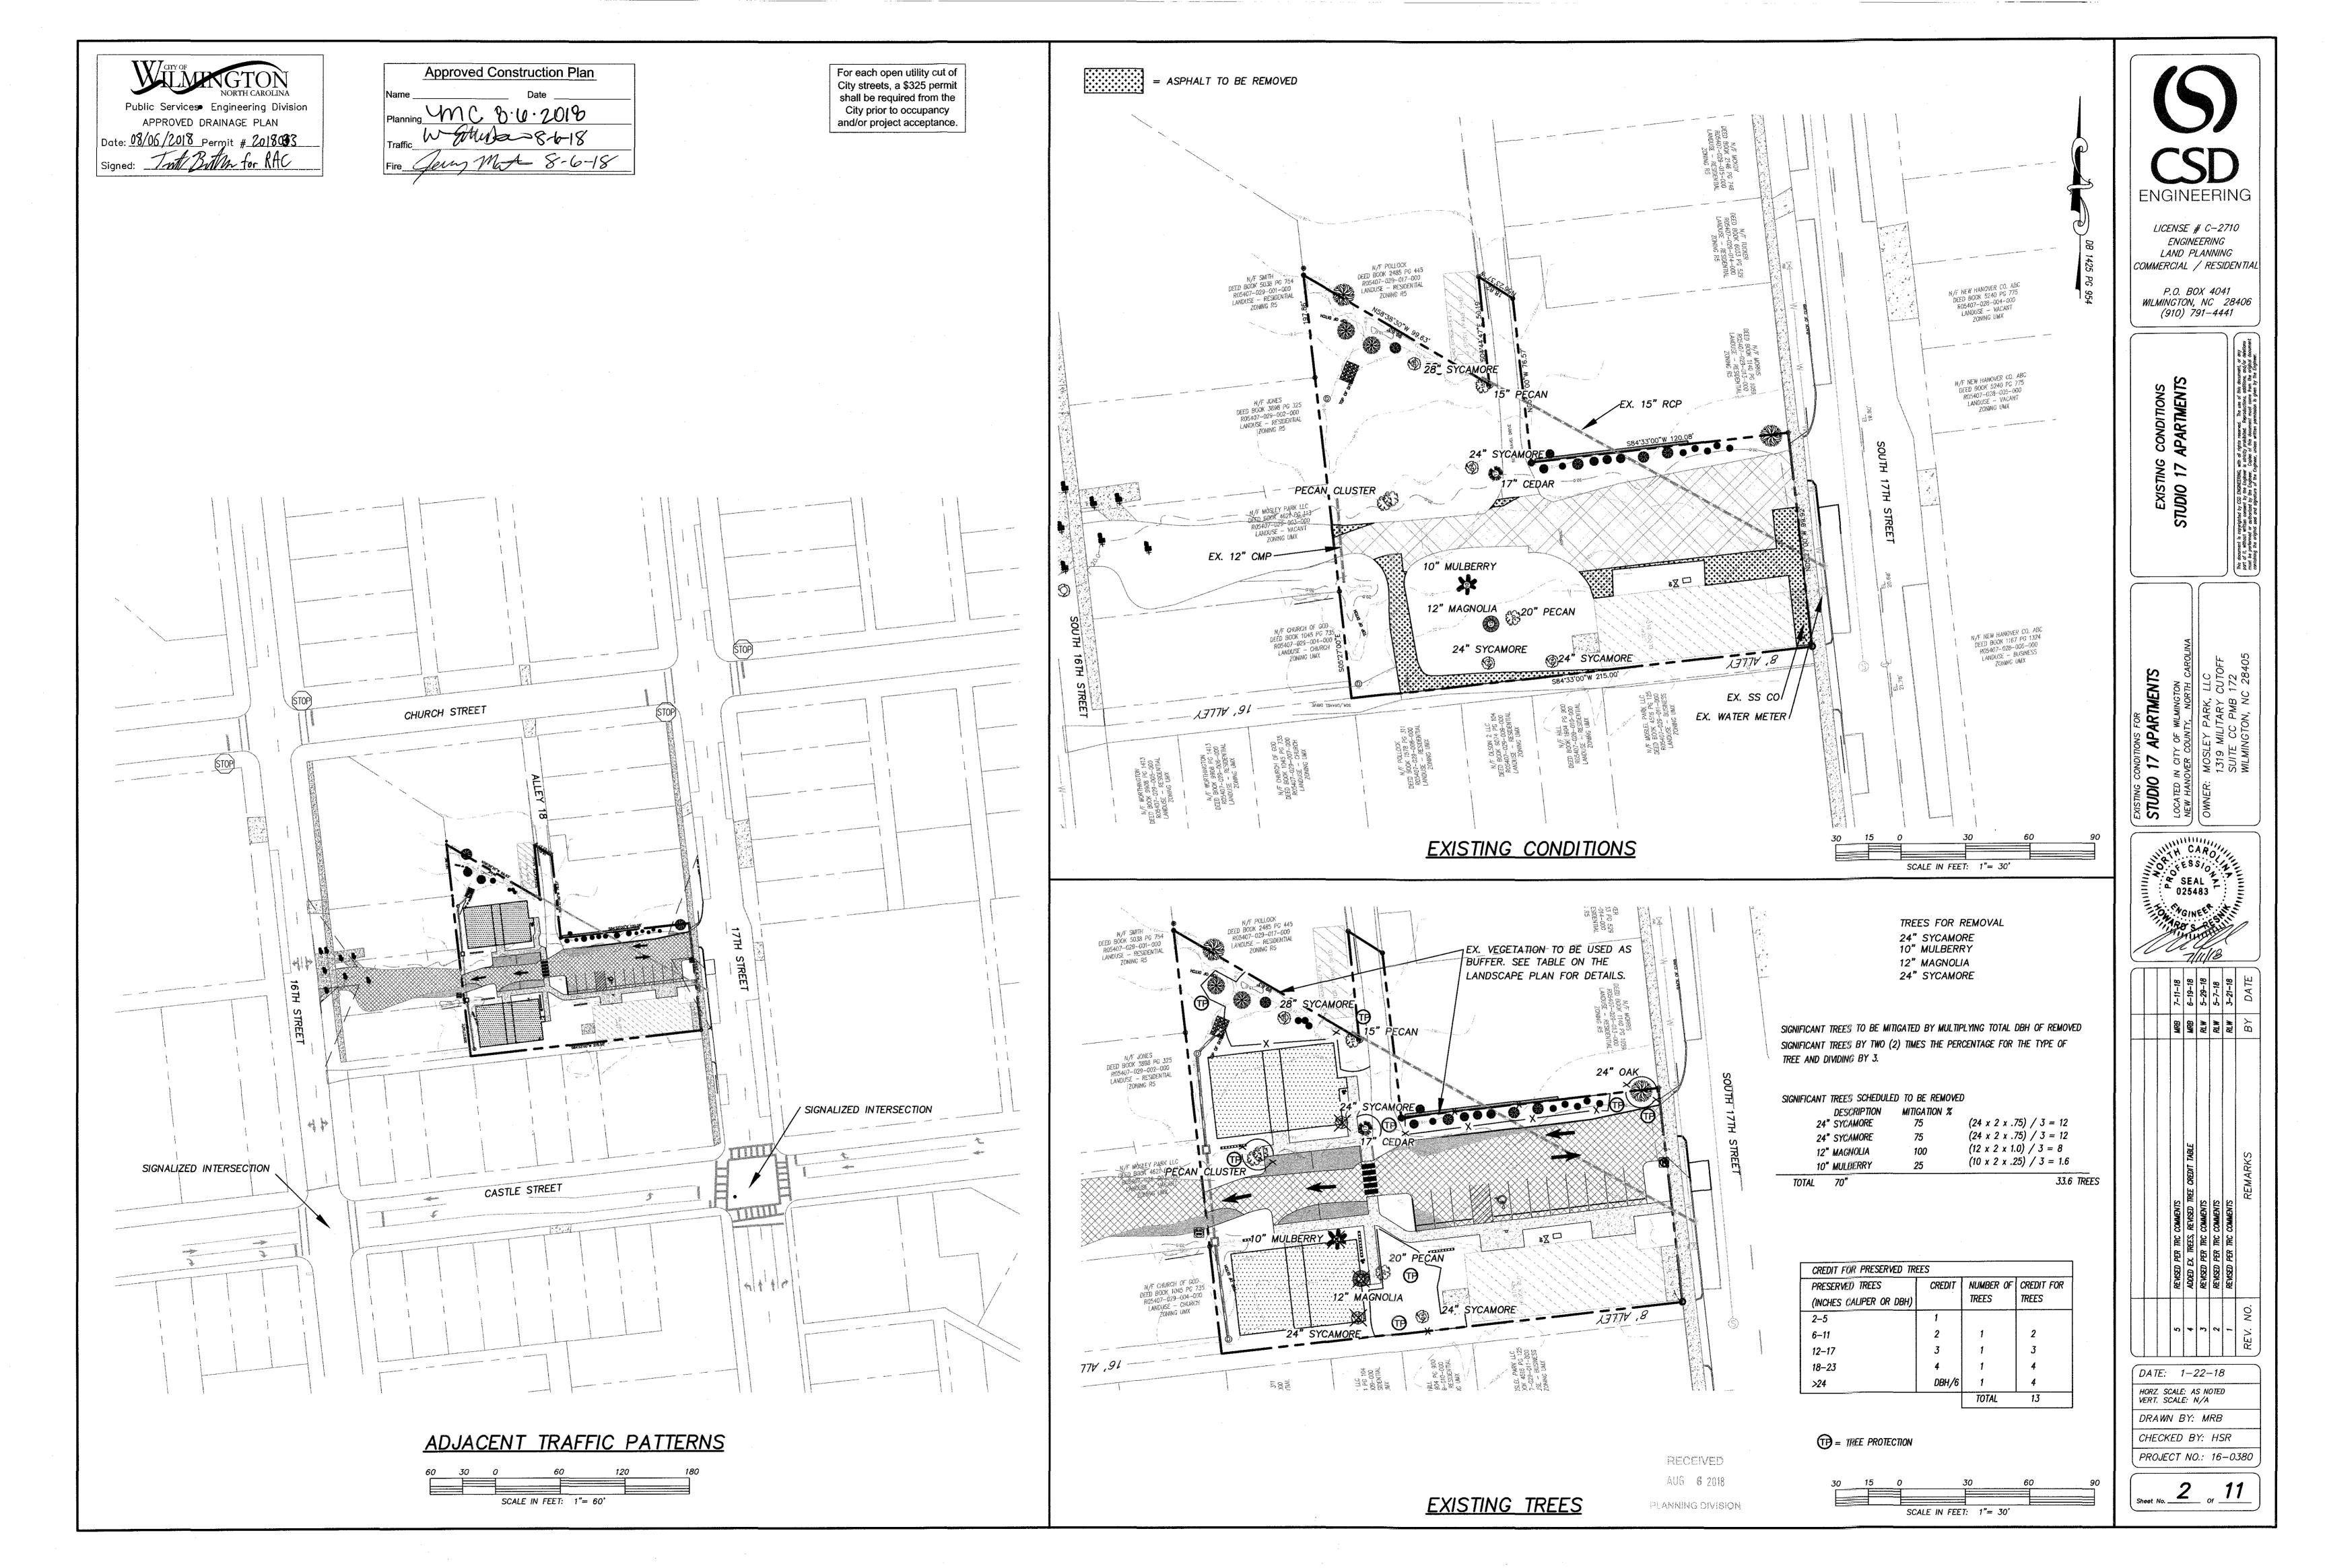


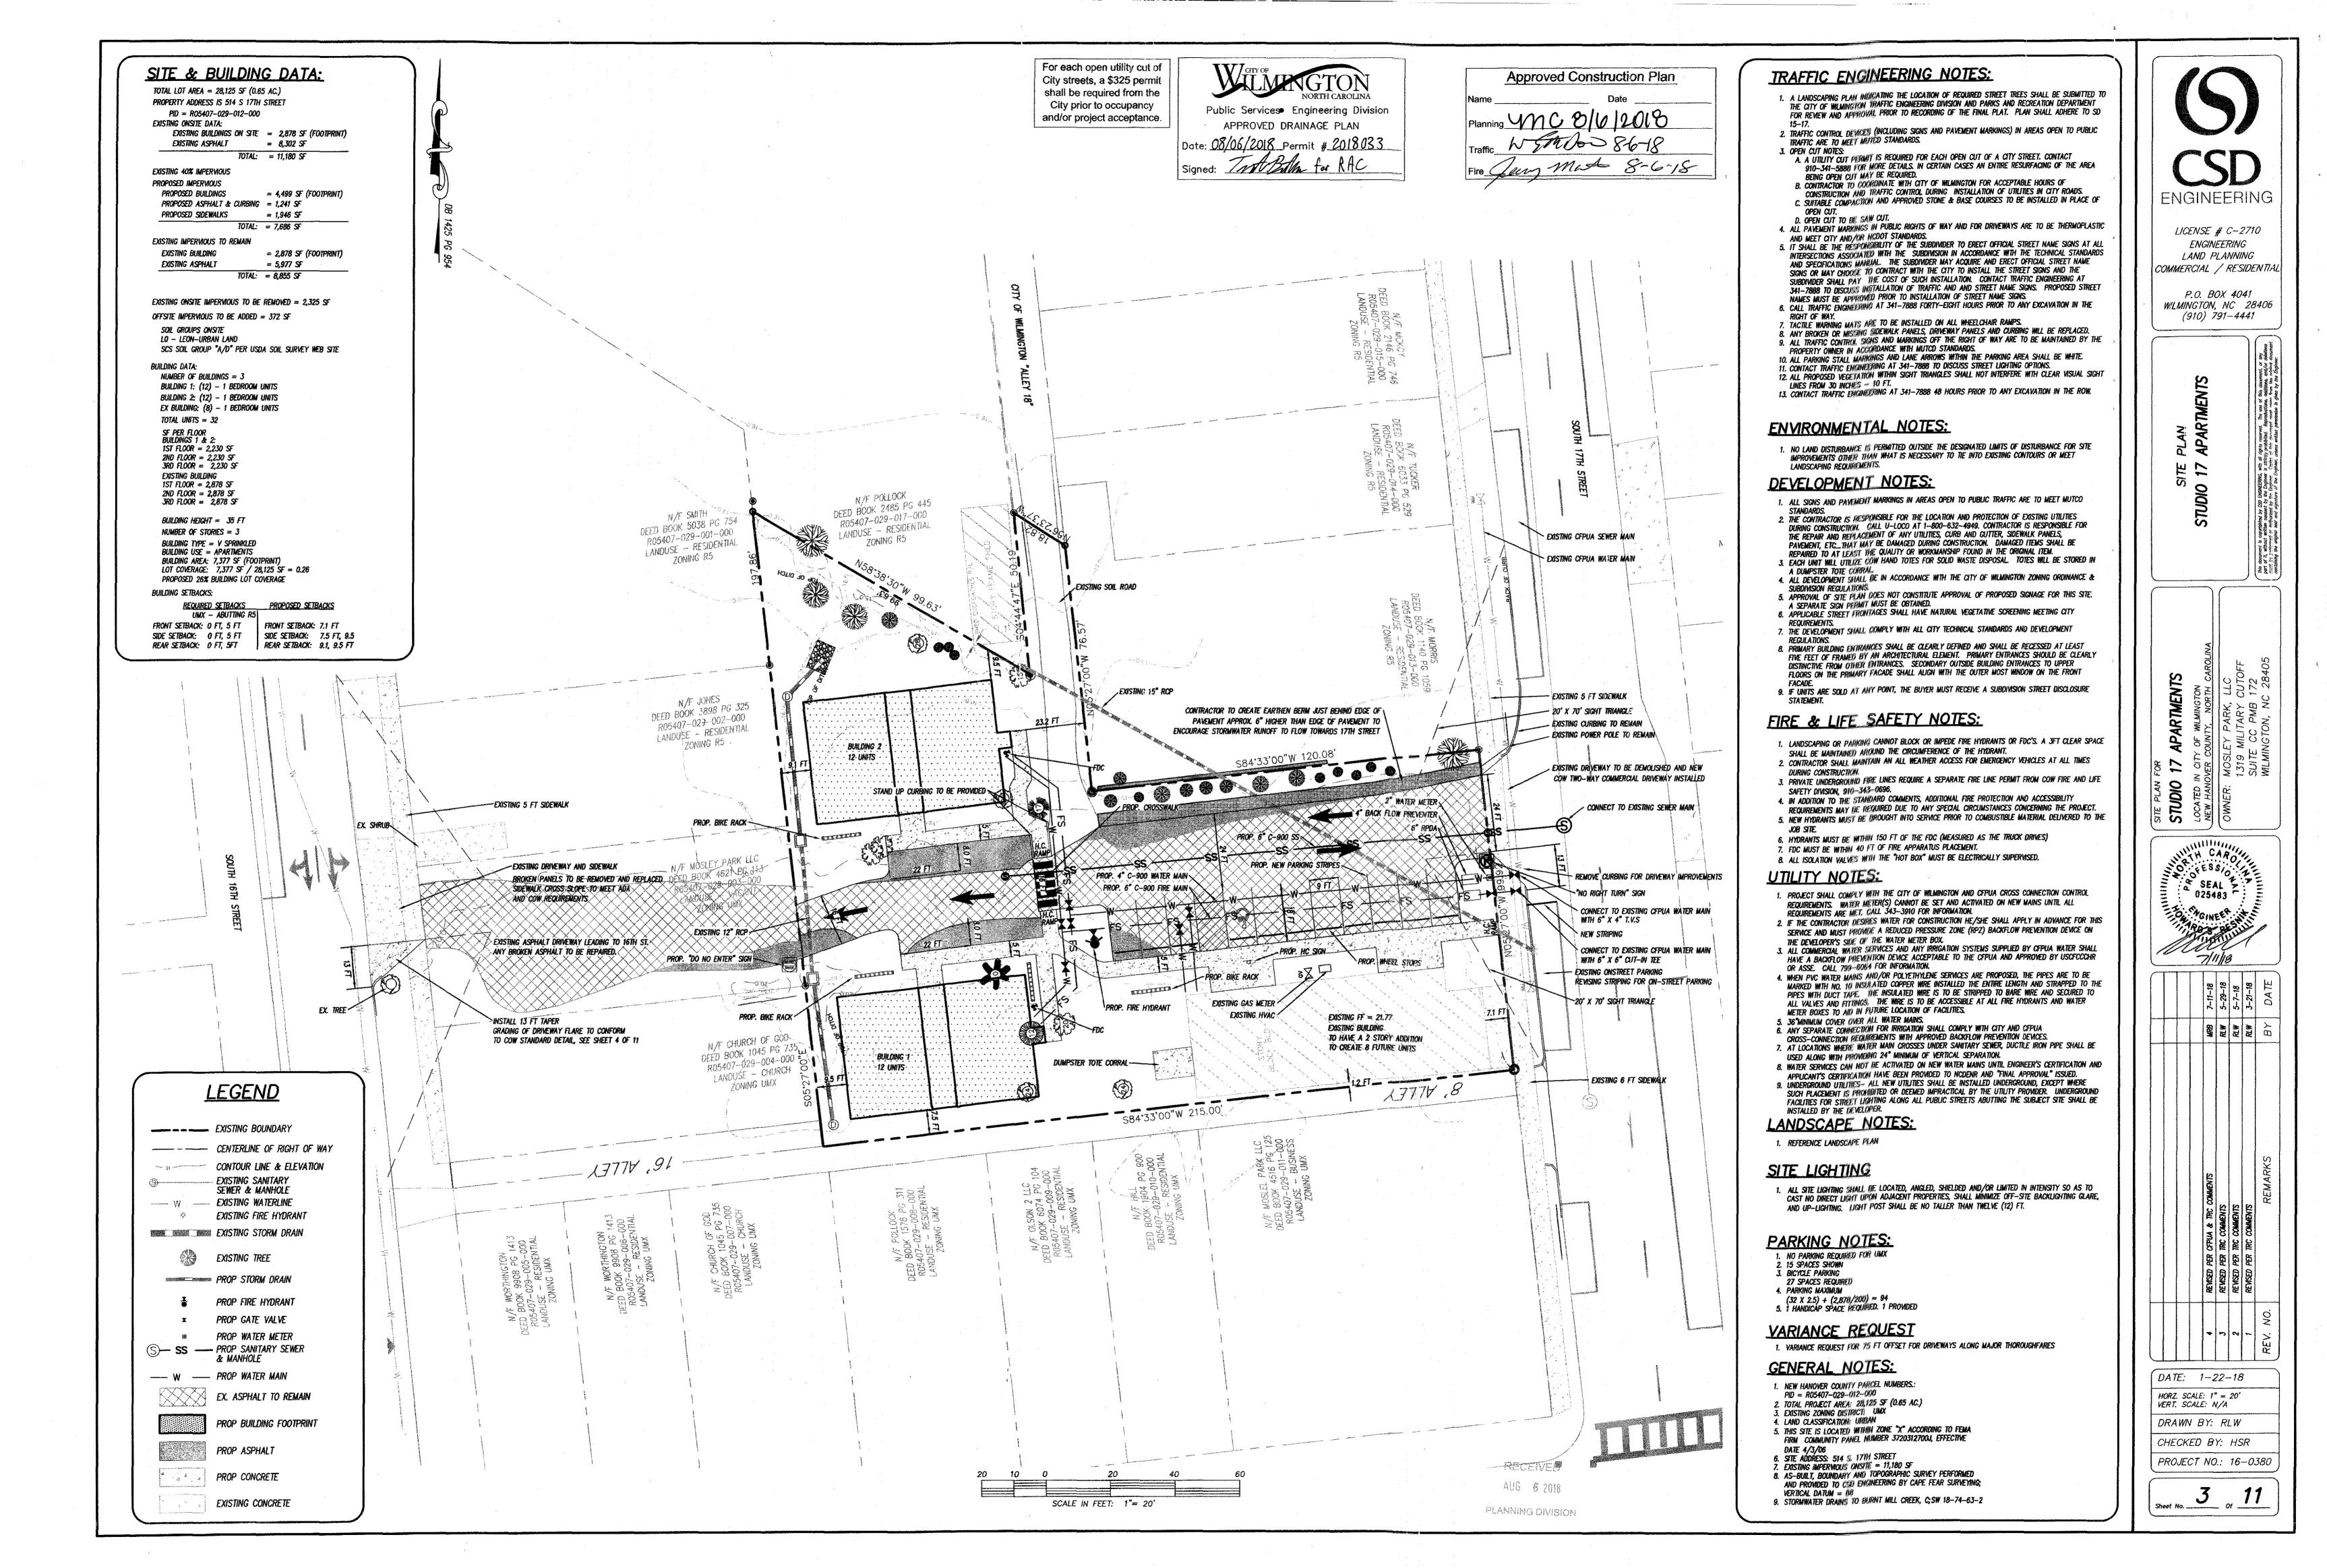



- 2. SANITARY SEWER CLEAN-OUTS, WATER METERS, MANHOLES, AND VALVE LIDS TO BE LOCATED OUTSIDE SIDEWALK WHERE FEASIBLE.
- 3. MINIMUM SIDEWALK WIDTH TO BE 6' MINIMUM IF PLACED AT BACK OF CURB.
- 4. CONCRETE FOR ALL SIDEWALKS (EXCEPT ANY PORTION CONTAIN WITHIN A DRIVEWAY APRON) SHALL BE CLASS "A" - 3,000 PSI.
- 5. MINIMUM REPLACEMENT FOR REPAIRS IS A 5' X 5' PANEL
- 6. 4" STONE BASE MAY BE REQUIRED FOR POOR SOIL CONDITIONS
- 7. MINIMUM DEPTH FOR TUNNELING BELOW SIDEWALK IS 12"
- 8. MAX ADJACENT GROUND SLOPE WITHOUT RAILING IS 2:1
- 9. MIN GRADE FOR PROPER DRAINAGE IS 1% IN AT LEAST 1 DIRECTION. MAX CROSS SLOPE IS 2%. MAX LONGITUDINAL SLOPE IS 8.3%, 10% IF LIMITED BY EXISTING CONDITIONS, OR NO GREATER THAN THE SLOPE OF THE EXISTING ADJACENT ROAD.


	STANDARD DETAIL	TV7 CETY OF
DATE: OCTOBER, 2010		WILMINGTON
DRAWN: PB/JSR		NORTH CAROLINA CITY OF WILMINGTON ENGINEERING
CHECKED: DEC	SIDEWALK	PO BOX 1810 WILMINGTON N.C. 28402
SCALE NOT TO SCALE		(910) 341–7807 SD 3-10

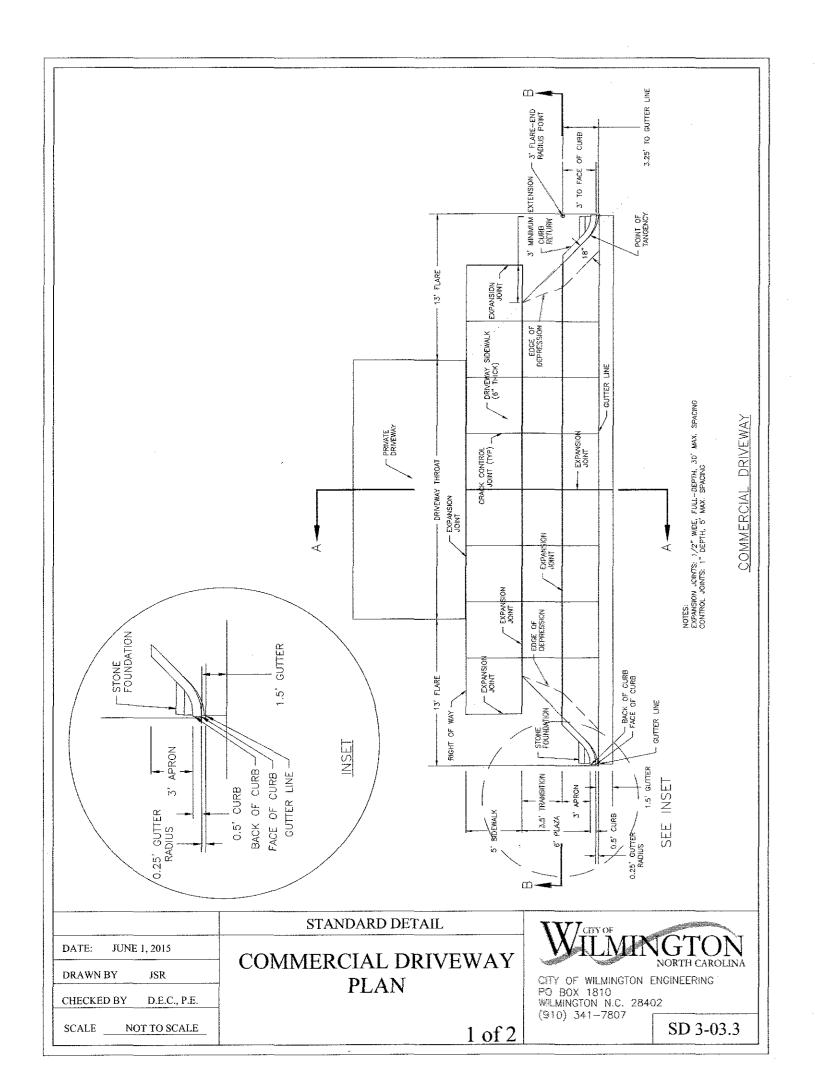

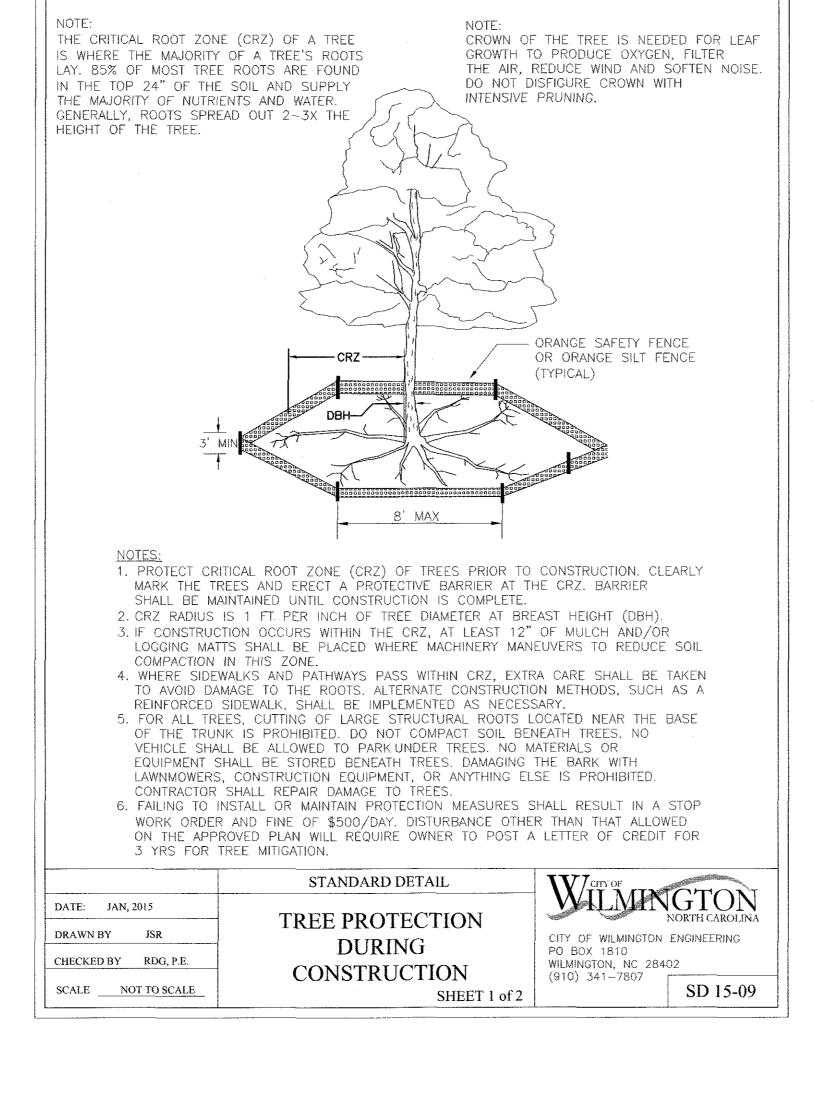

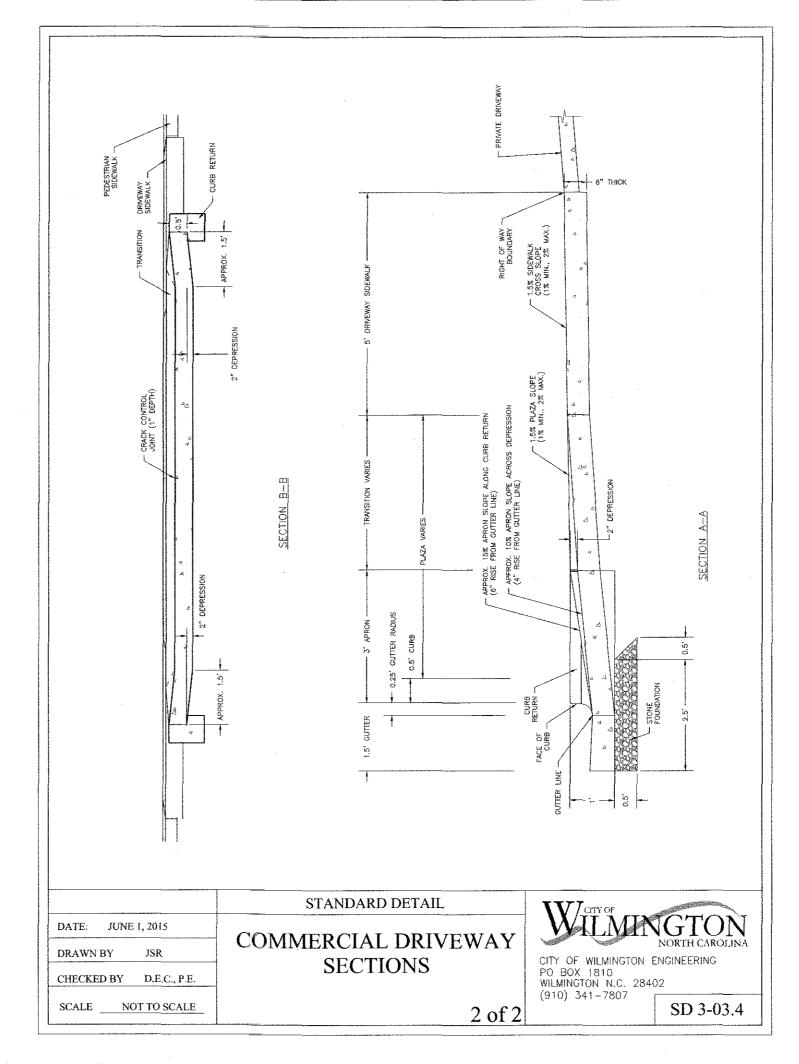

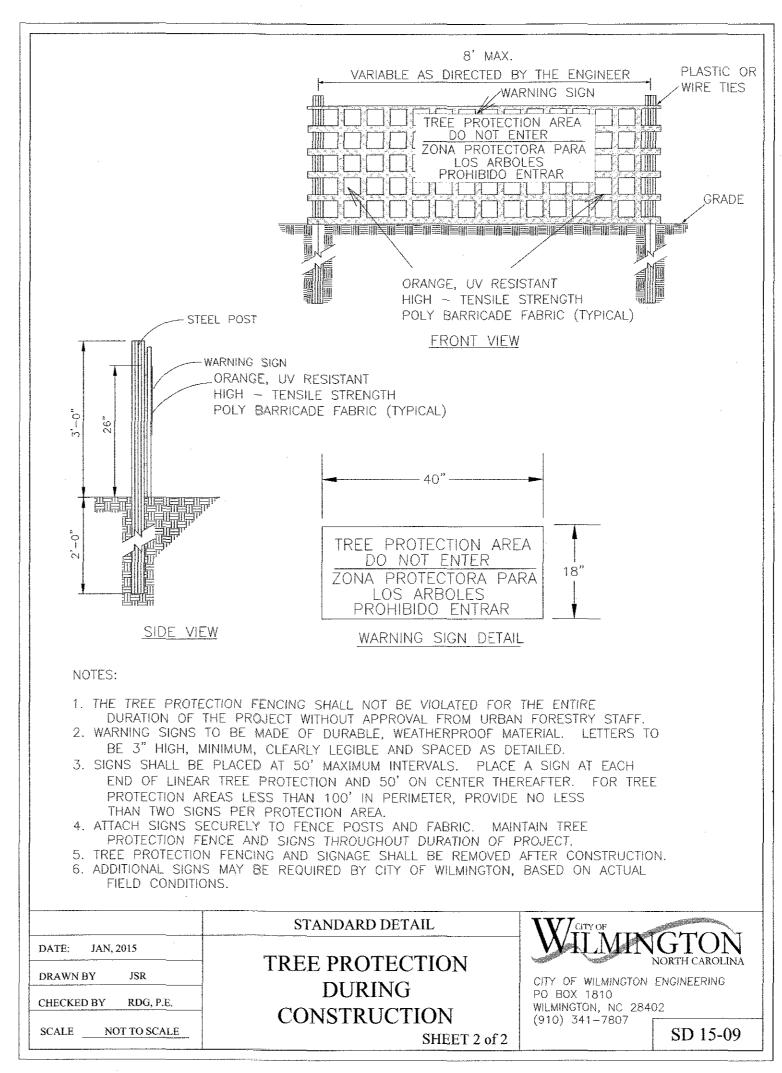

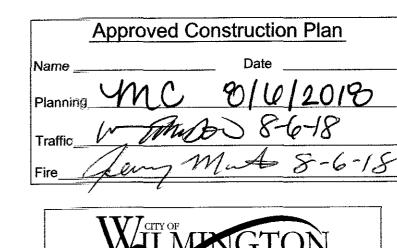


Public Services Engineering Division APPROVED DRAINAGE PLAN Date: 08/06/2018 Permit # 2018033
Signed: Tull Botton for RAC

> For each open utility cut of City streets, a \$325 permit shall be required from the City prior to occupancy and/or project acceptance.

ENGINEERING LICENSE # C-2710 ENGINEERING LAND PLANNING

COMMERCIAL / RESIDENTIAL P.O. BOX 4041 WILMINGTON, NC 28406 (910) 791-4441

STE 200 [NE] [NE] OW

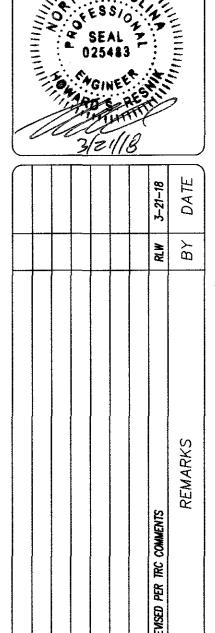


DATE: 1-22-18 HORZ. SCALE: AS NOTED VERT. SCALE: N/A

DRAWN BY: RLW CHECKED BY: HSR

PROJECT NO.: 17-0434

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PLANNING DIVISION

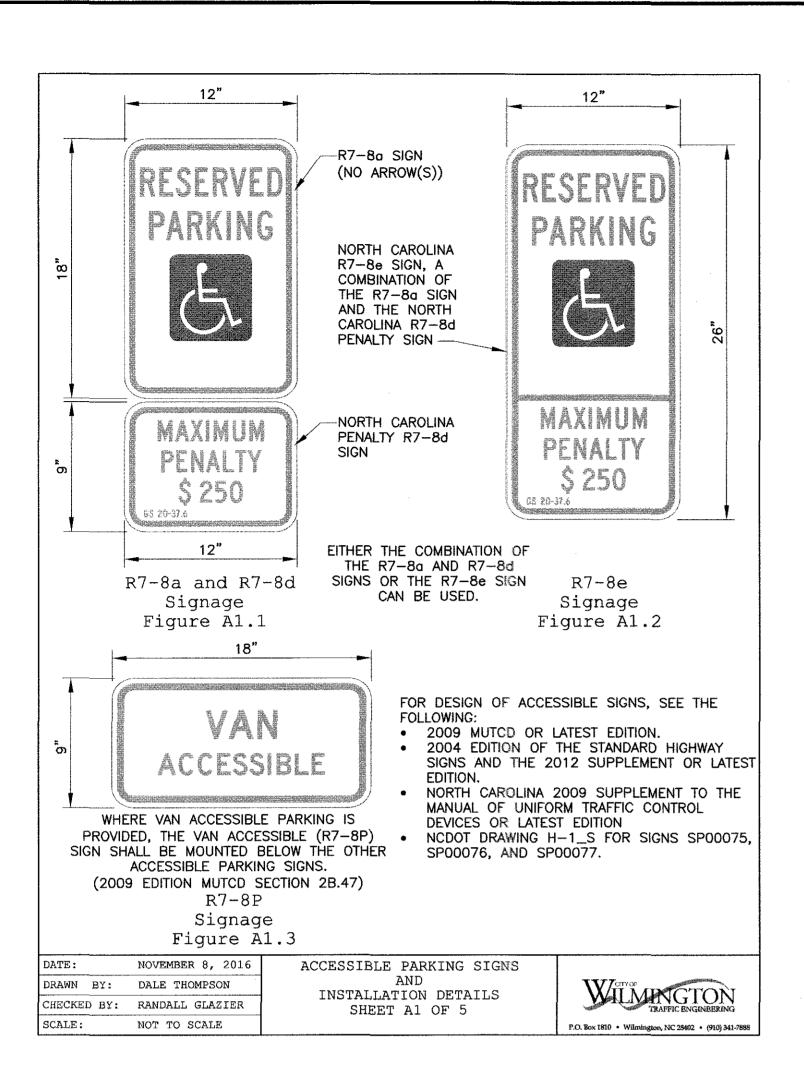

ACCESSIBLE RAMP-

ACCESSIBLE ROUTE-

ACCESSIBLE RAMP-

ACCESSIBLE ROUTE-

Between Building and

Figure A5.1

Spaces


Figure A5.2


NOVEMBER 8, 2016


DALE THOMPSON


NOT TO SCALE


CHECKED BY: RANDALL GLAZIER

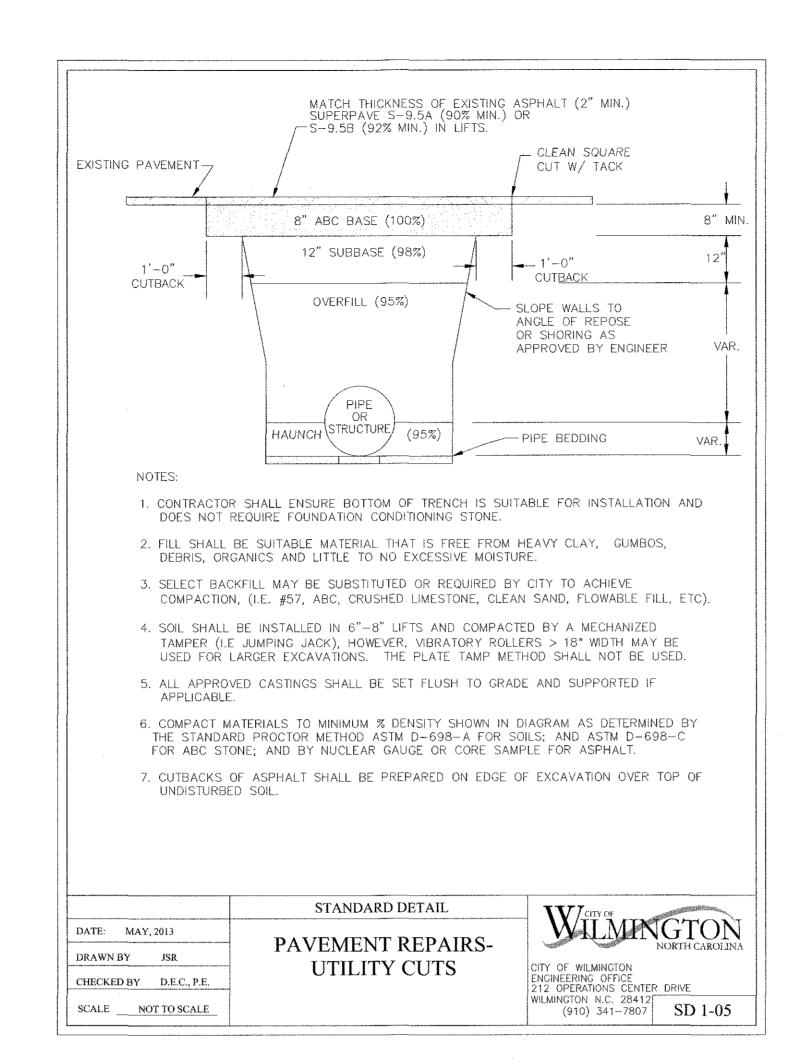

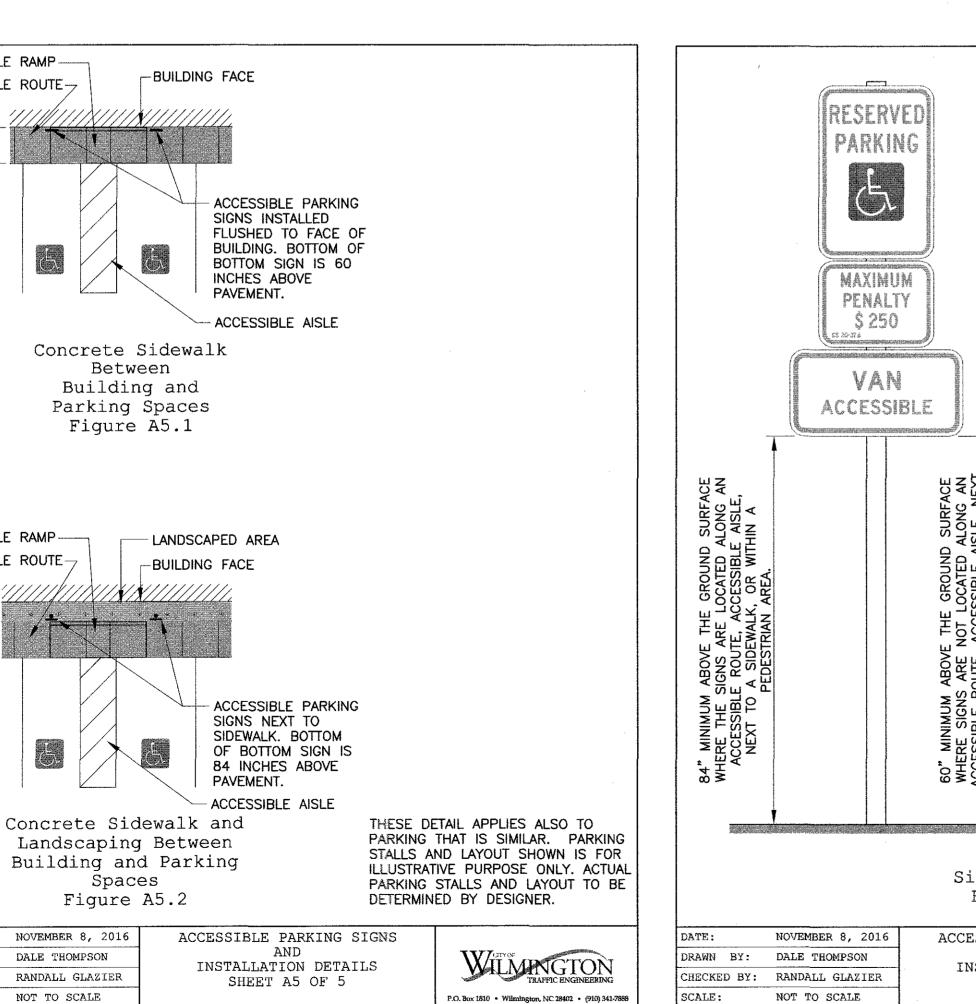

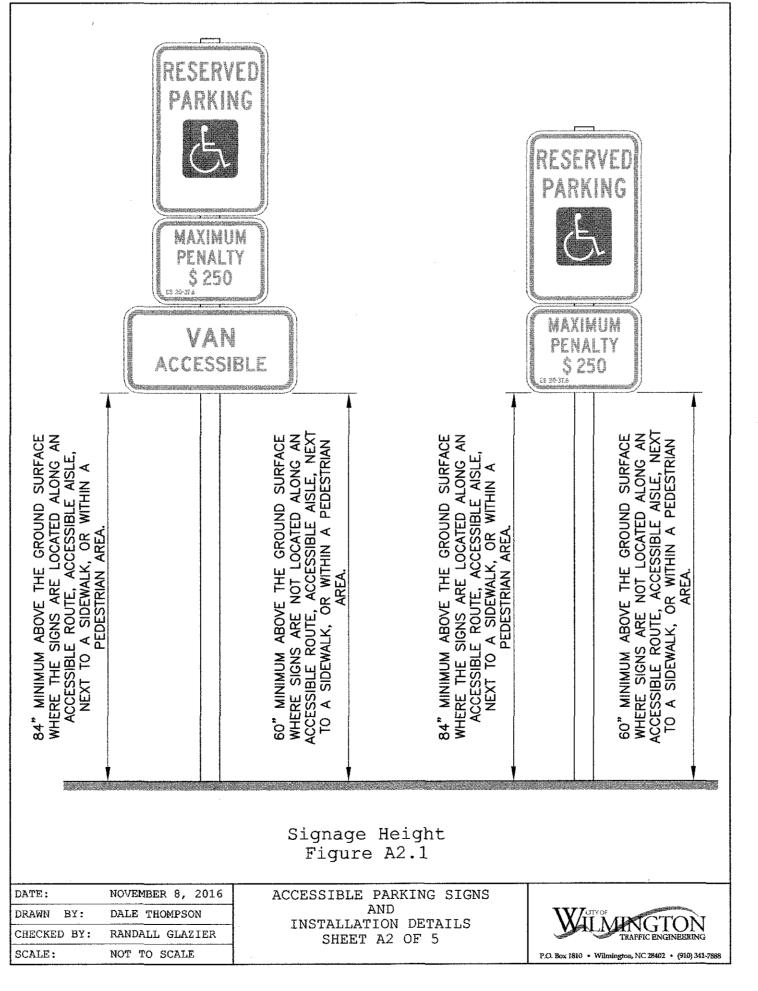

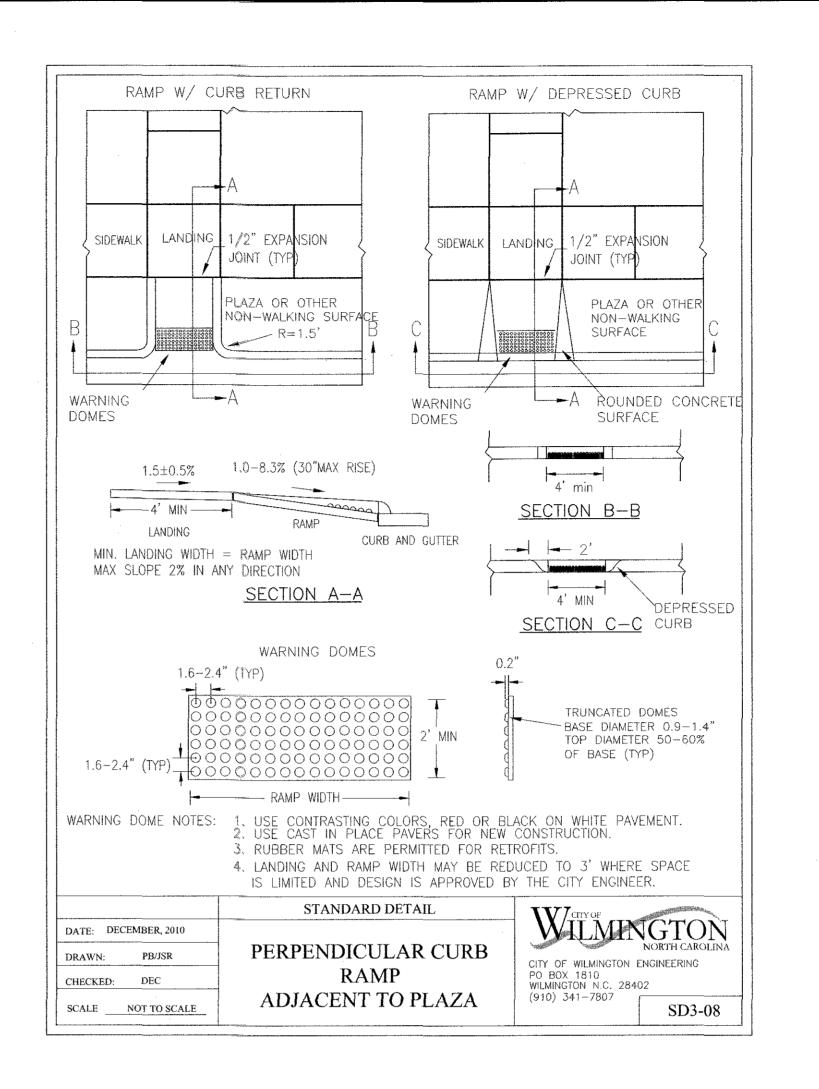

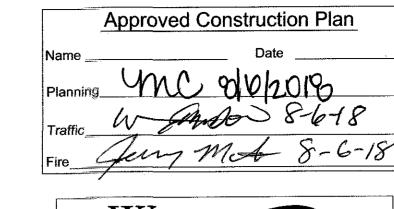



For each open utility cut of City streets, a \$325 permit shall be required from the City prior to occupancy and/or project acceptance.


ENGINEERING LICENSE # C-2710 ENGINEERING

LAND PLANNING COMMERCIAL / RESIDENTIAL

P.O. BOX 4041 WILMINGTON, NC 28406 (910) 791-4441

PLAN DETAILS

17 APARTMENTS SITE STUDIO

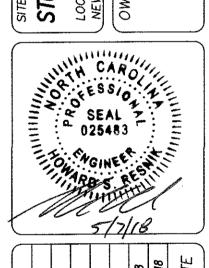

SEV. NO. REMARKS SITUATION REV. NO. REMARKS SITUATION REMARKS REMARKS								
2 REVISED PER TRC COMMENTS 1 REVISED PER TRC COMMENTS REV. NO.					RL#	RLW	ВҮ	
					REVISED PER TRC COMMENTS	REVISED PER TRC COMMENTS		
DATE: 1-22-18					2	ł	REV. NO.	
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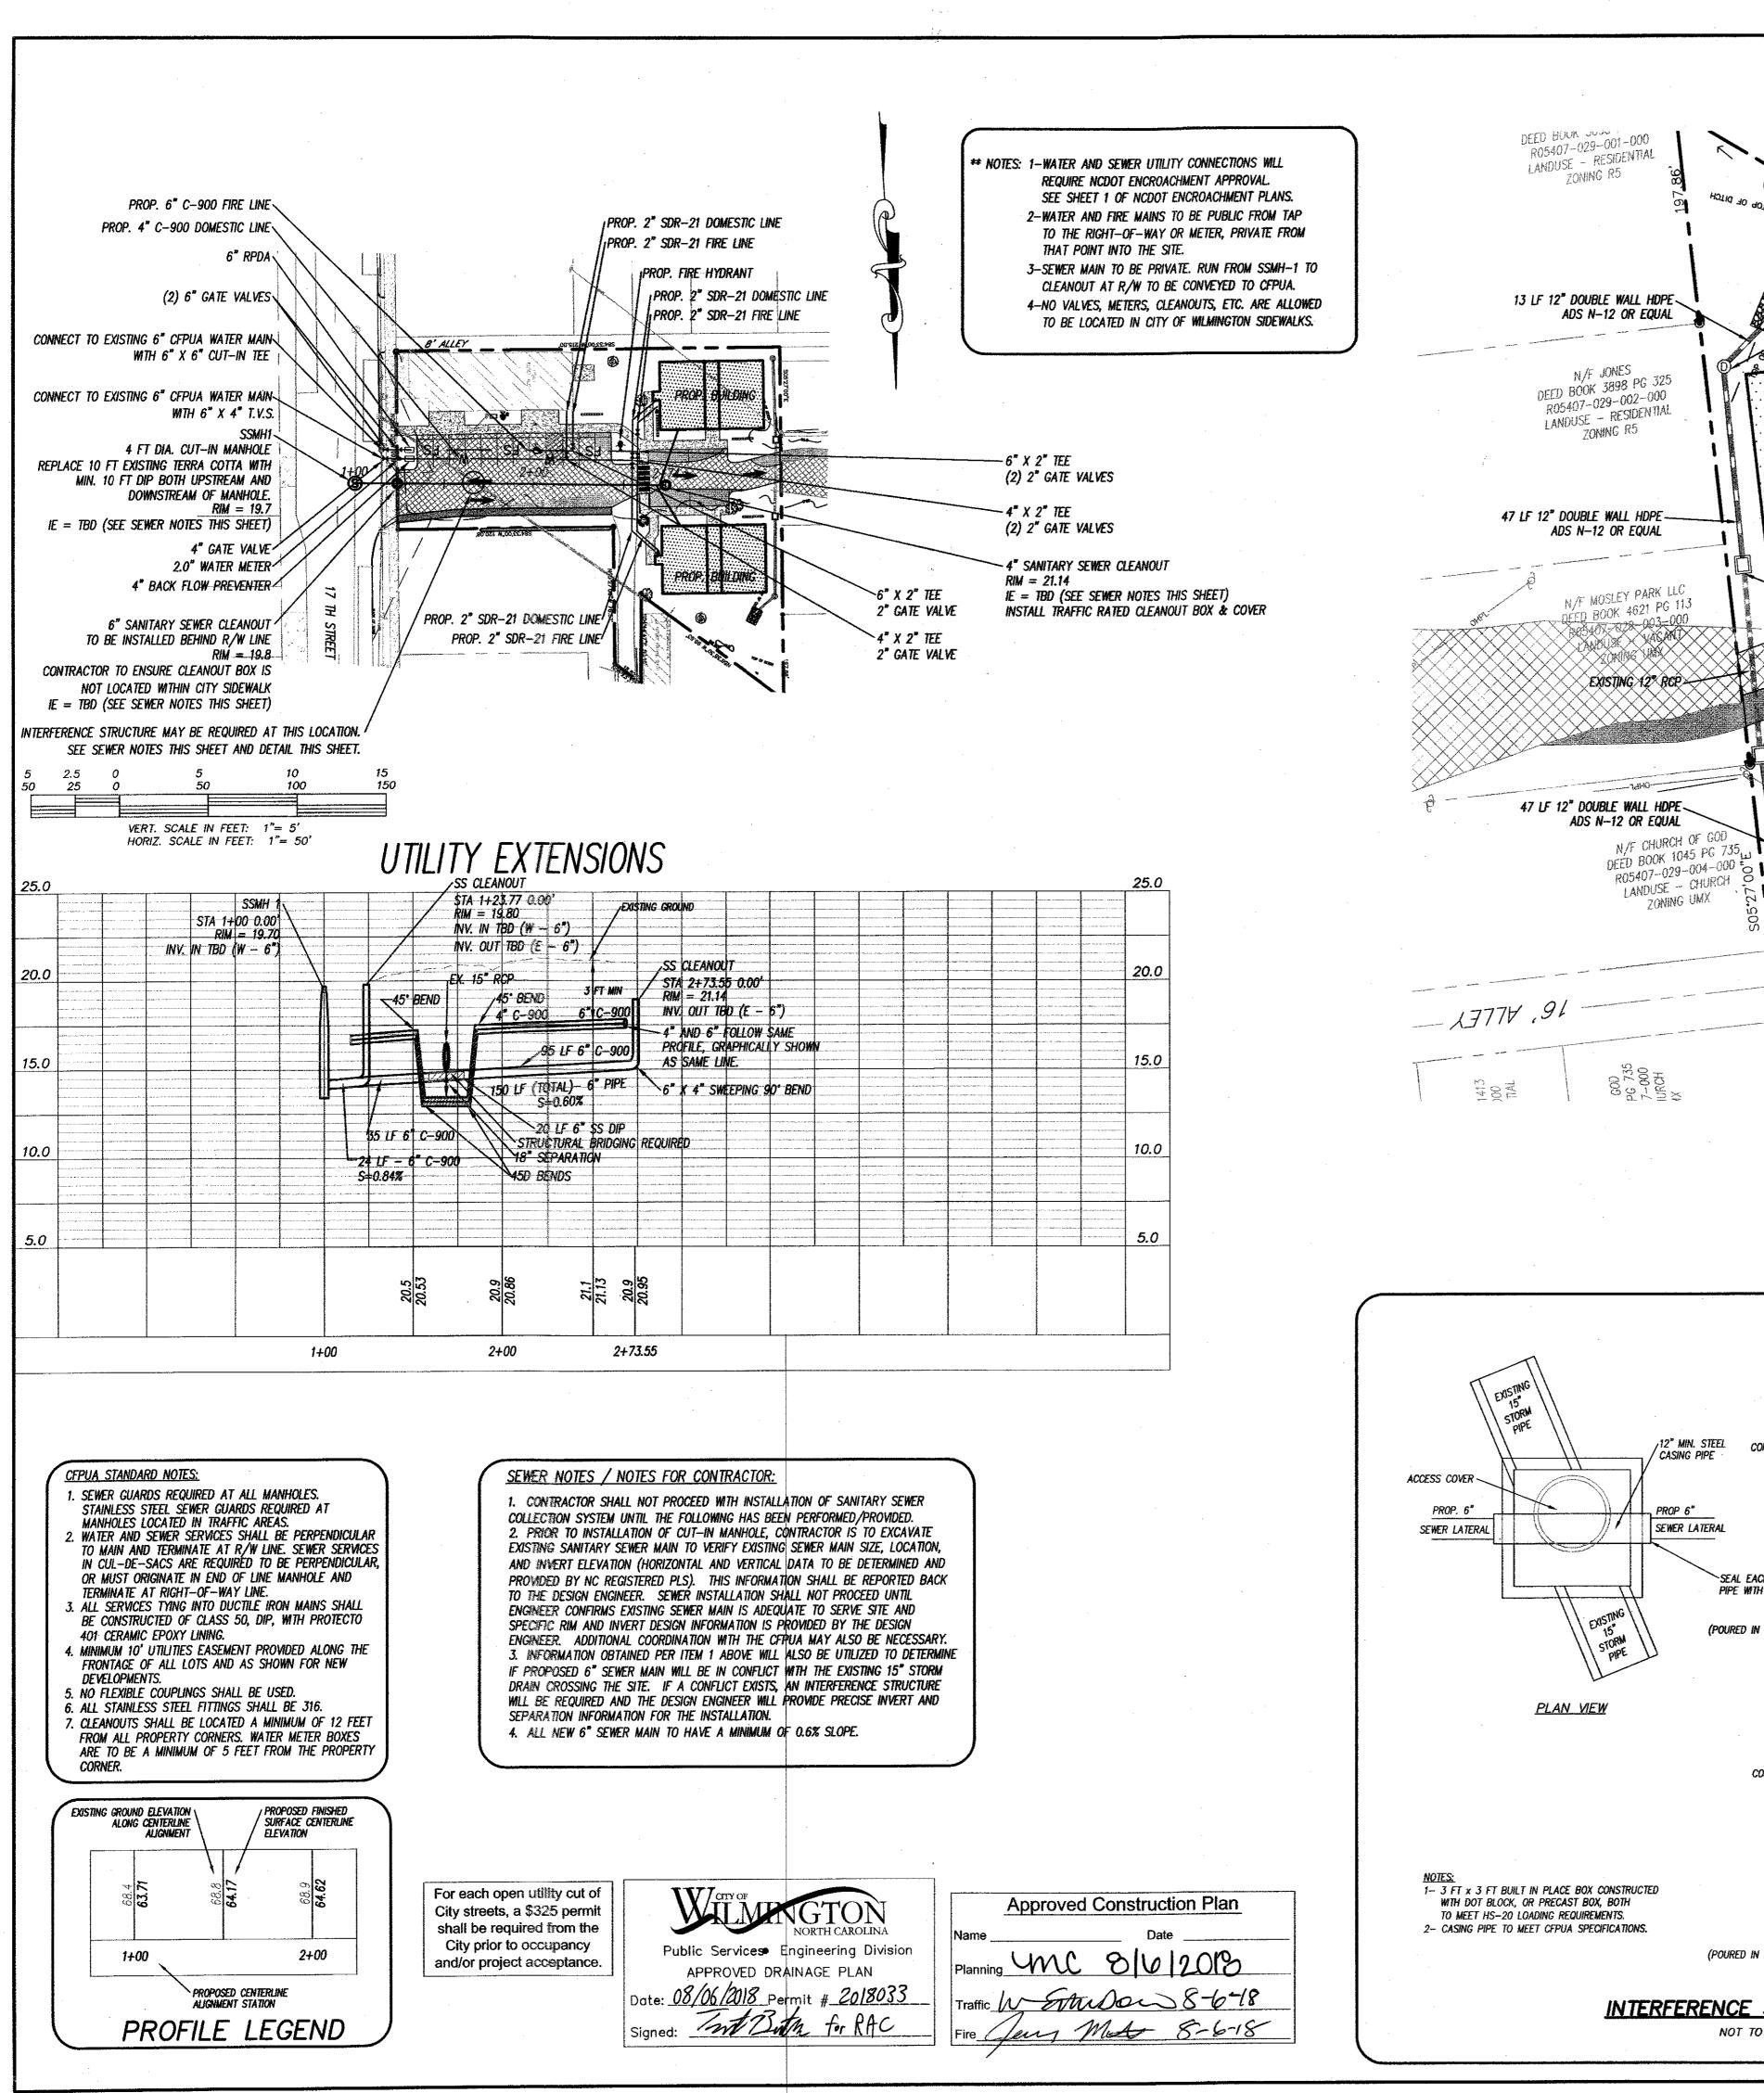
PROJECT NO.: 17-0434


HORZ. SCALE: AS NOTED

DRAWN BY: RLW


CHECKED BY: HSR

VERT. SCALE: N/A



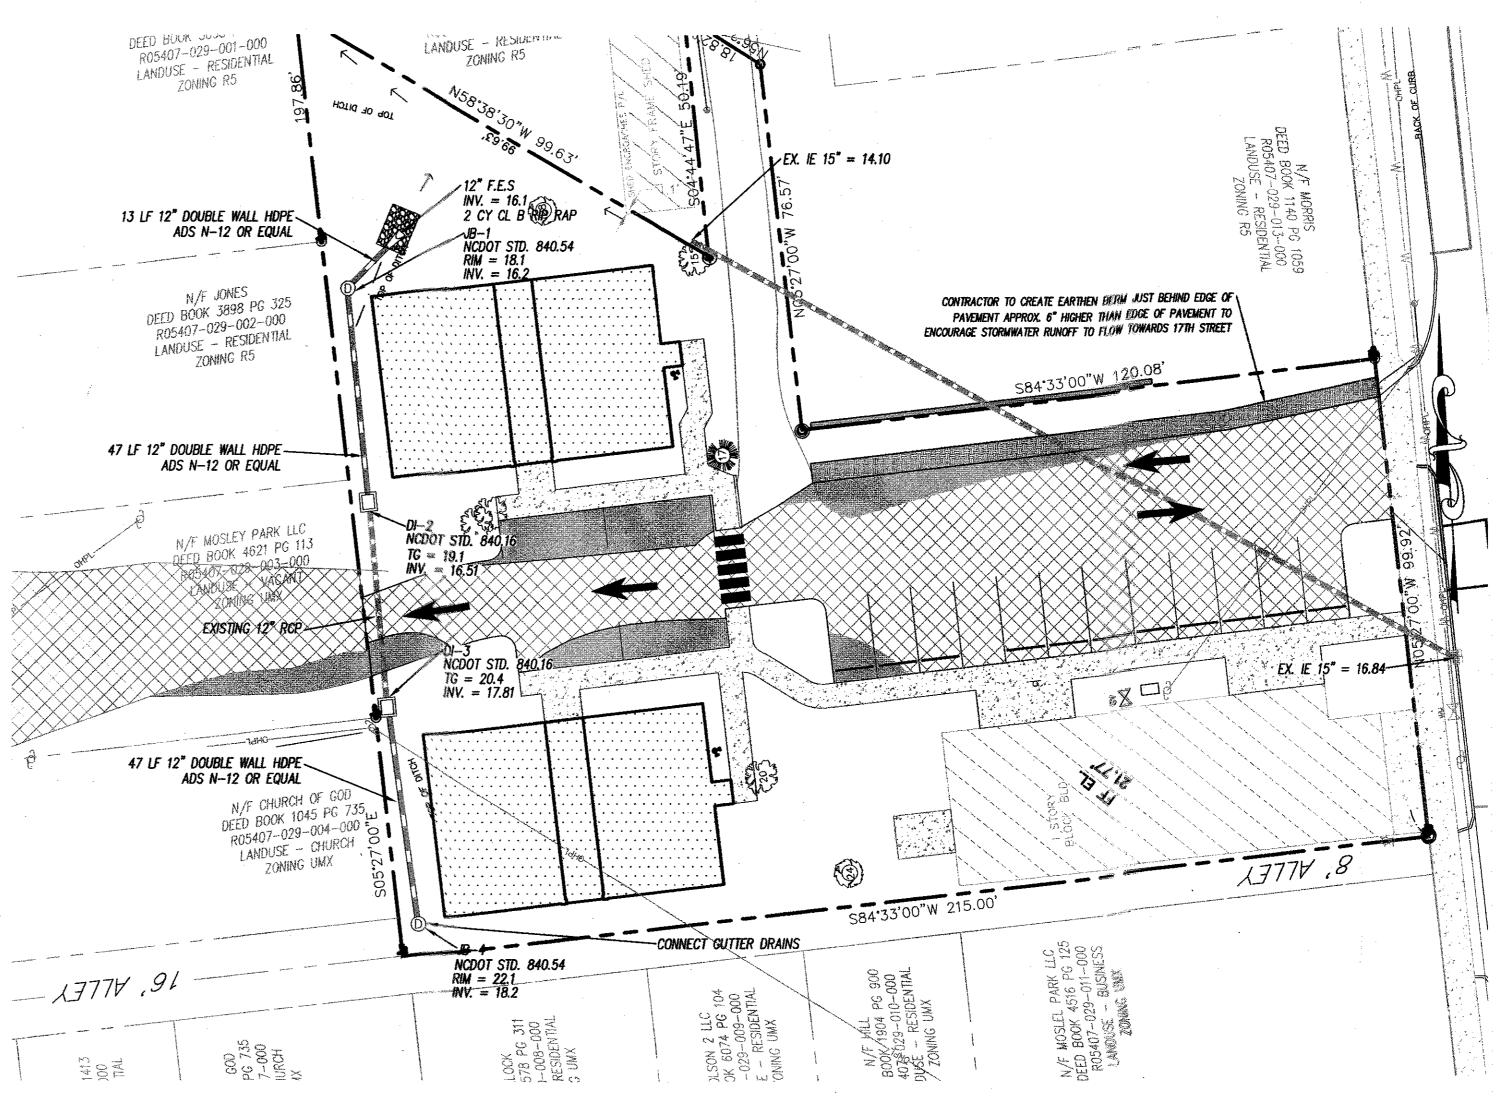


STORM DRAINAGE IMPROVEMENTS

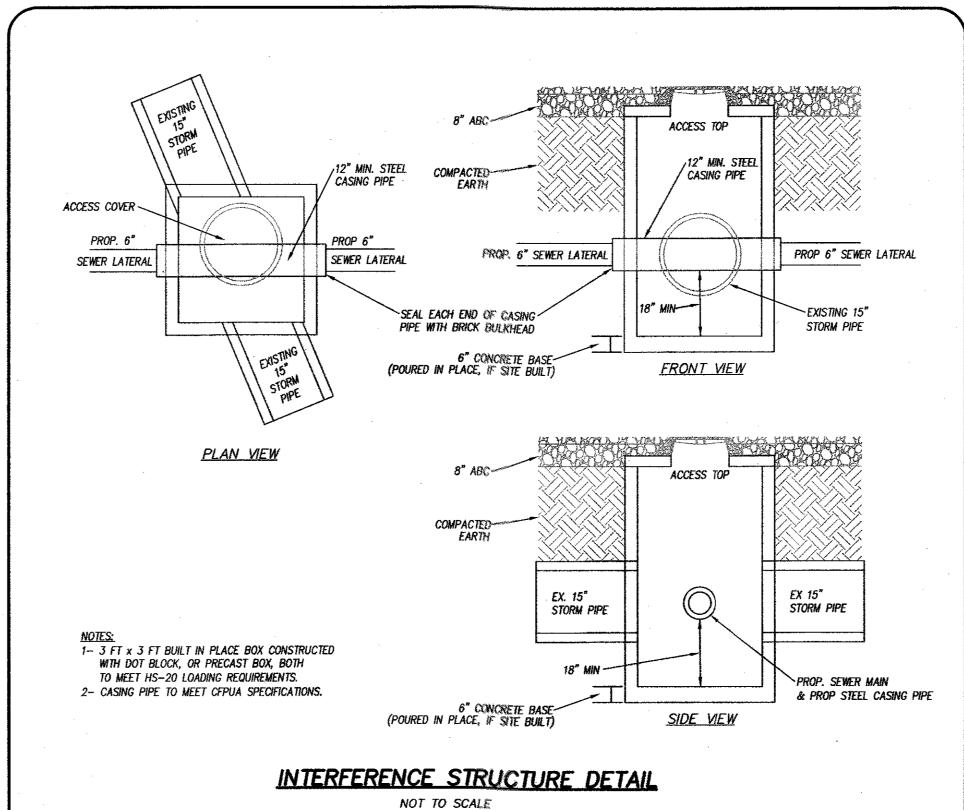

STORMWATER DRAINAGE STRUCTURE NOTES

- 1. Contractor and precaster to determine storm
- STRUCTURE SIZES.
- 2. FRAME AND GRATES TO BE NCDOT 840.16
- 3. RING AND COVERS TO BE NCDOT STD. 840.54 3. STORM STRUCTURES TO BE NCDOT STD. 840.14
- 4. PRECAST STORM STRUCTURES TO MEET HS-20-44
- 5. CONTRACTOR TO INSTALL ACCESS COVERS SO THEY ARE NOT LOCATED WITHIN THE CURB AND GUTTER

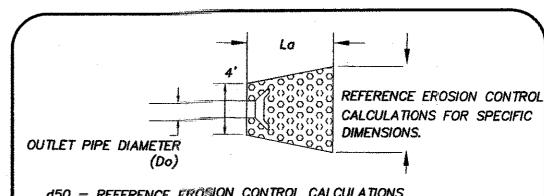


d50 = REFERENCE EROSION CONTROL CALCULATIONS dMAX = REFERENCE EROSION CONTROL CALCULATIONS La = REFERENCE EROSION CONTROL CALCULATIONS MIN. APRON THICKNESS = 4.5"

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PLANNING DIVISION

NOTE: GEOTEX NONWOVEN FILTER FABRIC (TERRATEX NO4 OR EQUAL) TO BE PLACED UNDER ALL STONE OUTLET PROTECTION.



@ OUTLET PROTECTION DETAIL

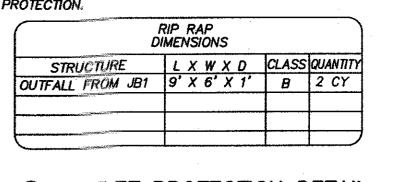
NOT TO SCALE

ENGINEERING

LICENSE # C-2710 ENGINEERING LAND PLANNING COMMERCIAL / RESIDENTIAL

P.O. BOX 4041 WILMINGTON, NC 28406 (910) 791–4441


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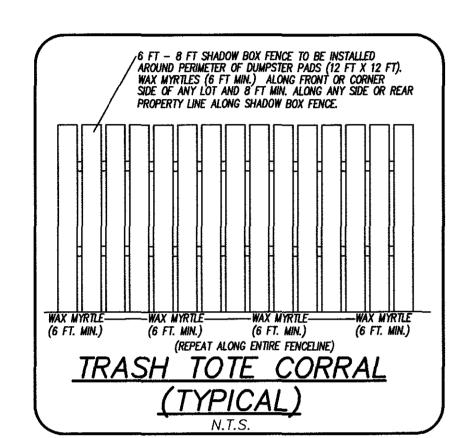
			аым	RLW	RLW	RLW	RLW	ВУ
			REVISED PER CYPUA COMMENTS	REVISED WATER SYSTEM	REVISED WATER SYSTEM	REVISED PER TRC COMMENTS	REVISED PER IRC COMMENTS	REMARKS
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VERT. SCALE: N/A DRAWN BY: RLW CHECKED BY: HSR PROJECT NO.: 17-0434

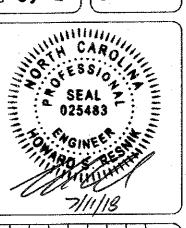Sheet No. 6





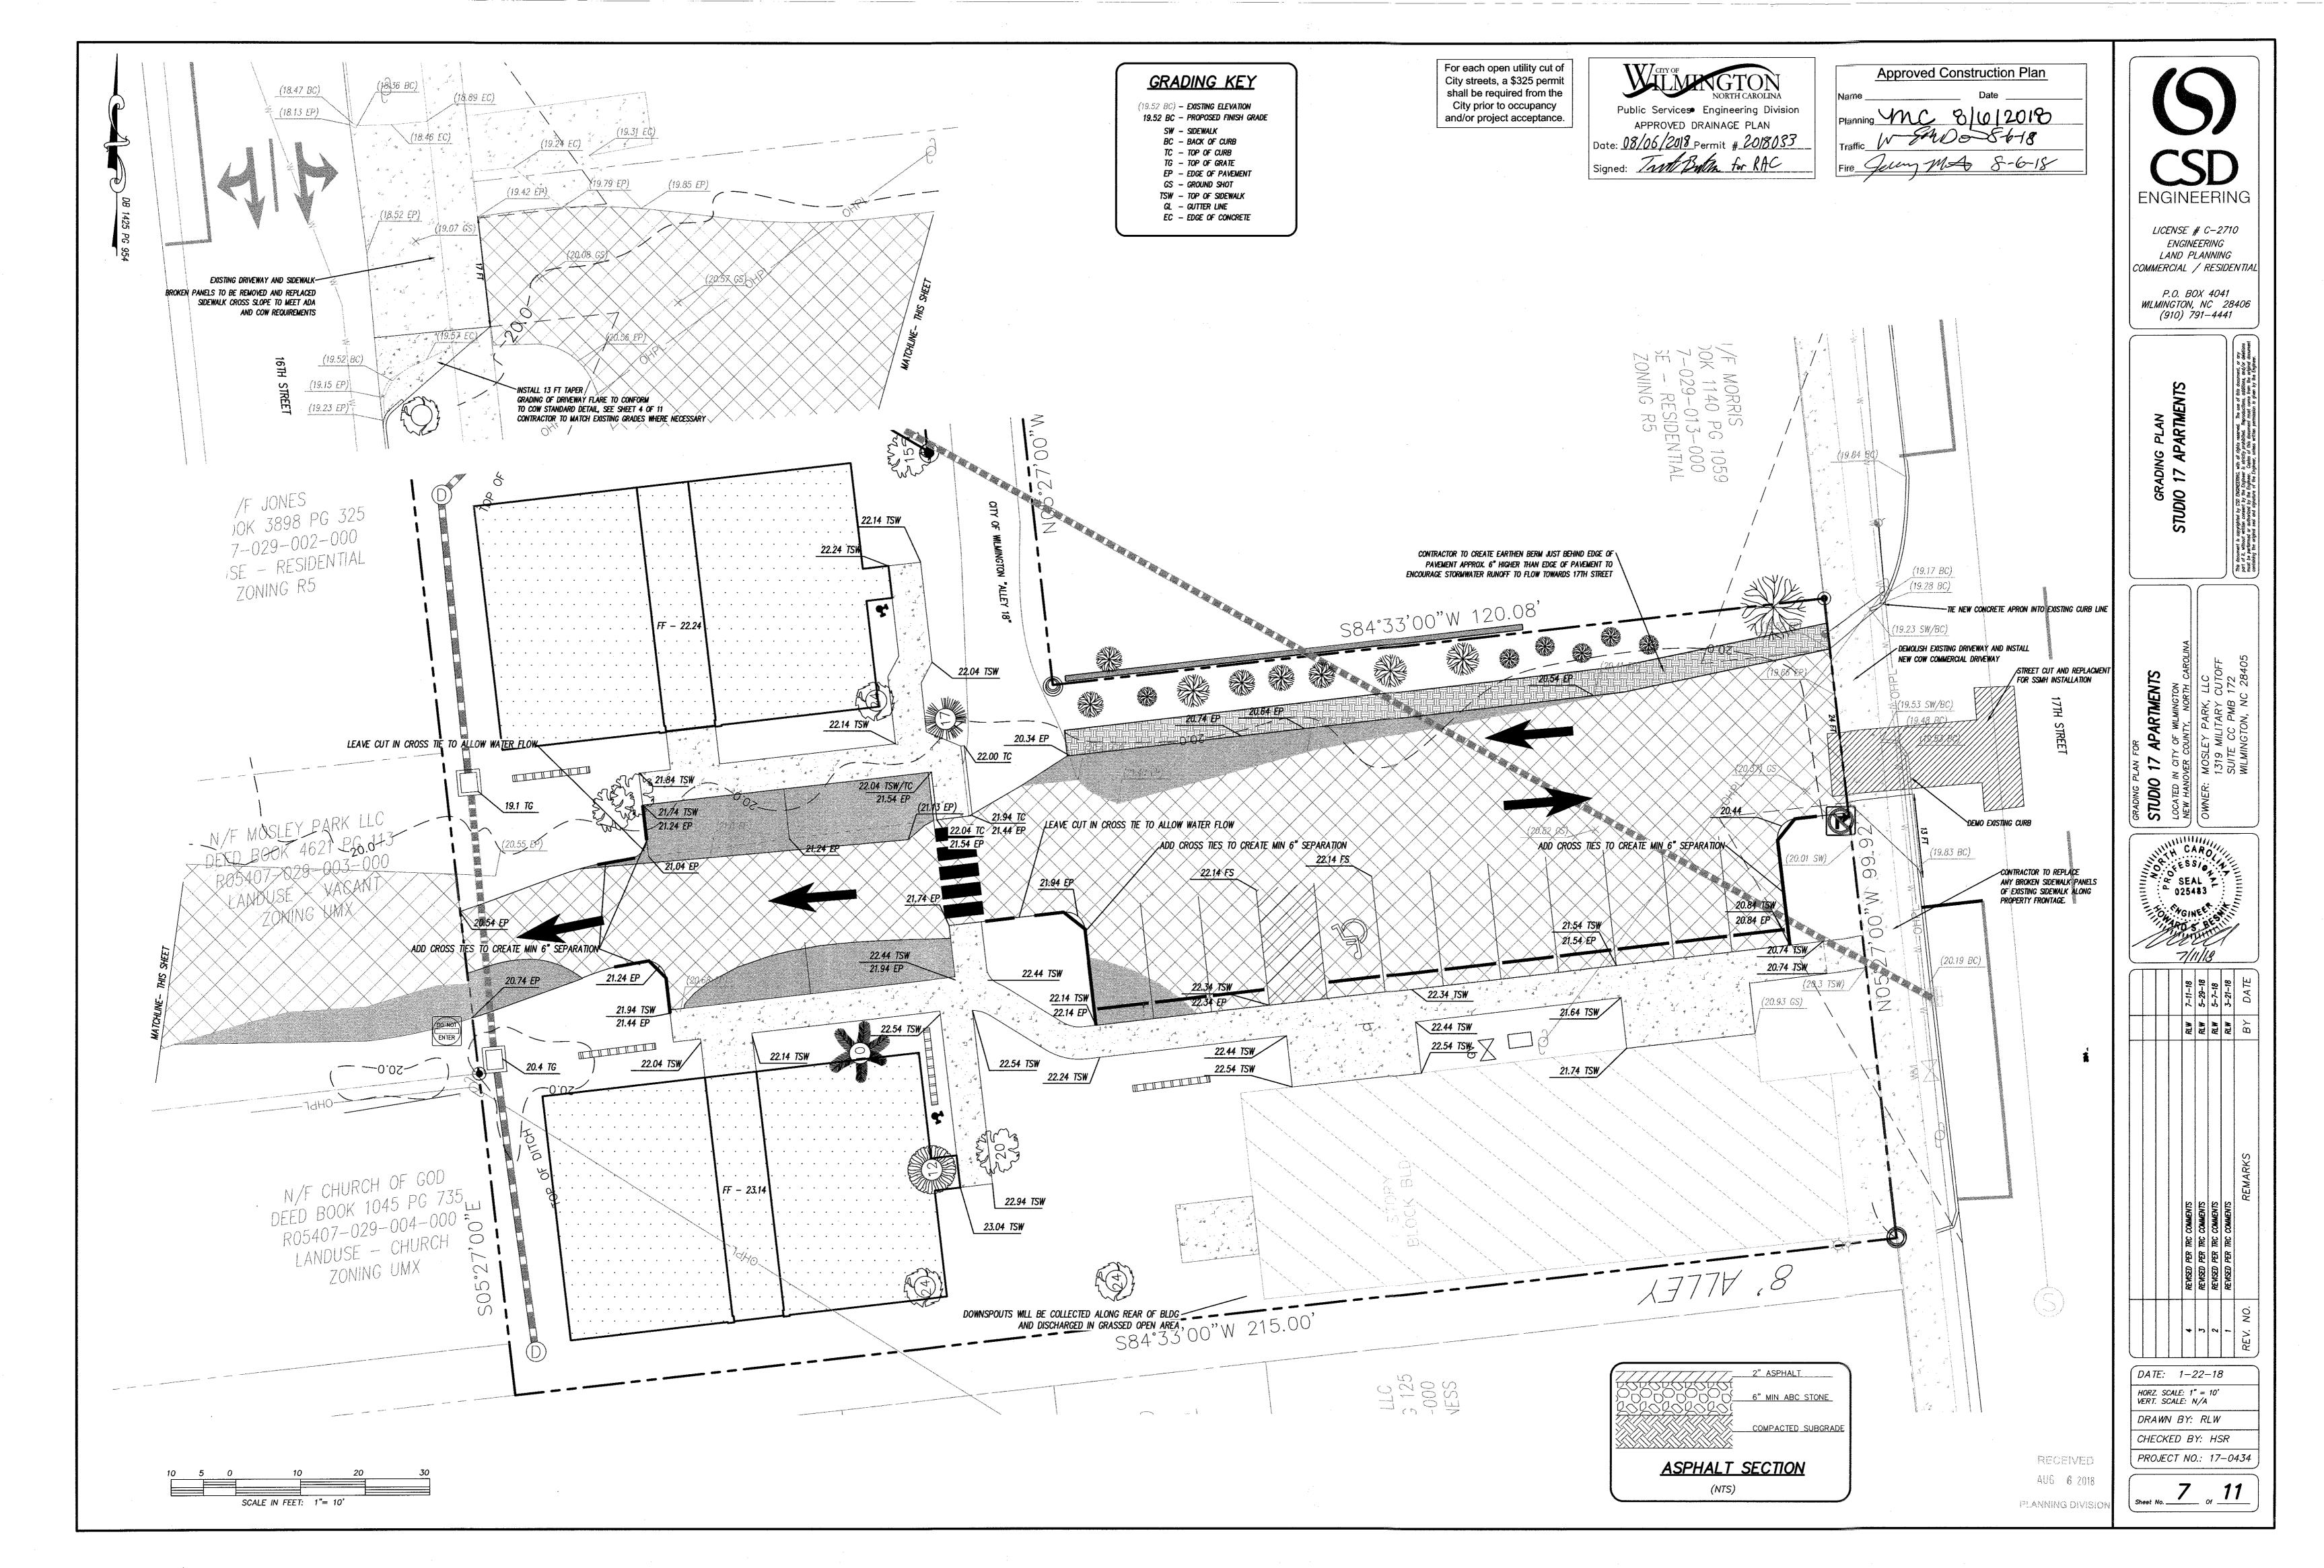

LANDSCAPING NOTES:

FOUNDATION PLANTINGS

NORTH SIDE BUILDING FACE = 1,800 SF $1,800 \times 0.12 = 216 \text{ SF REQD, } 216 \text{ SF PROVIDED.}$

BUILDING FACE = 1,800 SF

1,800 X 0.12 = 216 SF REQ'D, 216 SF PROVIDED.

EX, BUILDING BUILDING FACE = 2,400 SF $2,400 \times 0.12 = 288 \text{ SF REQ'D}$, 288 SF PROMDED.

STREET TREES 100 - 24 = 76 FT

76 / 30 = 2.5 STREET TREES REQUIRED REQUESTING PAYMENT IN LIEU FOR STREET TREES DUE TO SITE CONSTRAINTS. LESS THAN 3 FT FROM BACK OF CURB TO EXISTING

PARKING LOT SHADING


- 707 SF FOR CANOPY TREE

20% Shading req'd for parking areas. 7,218 Parking area \times 20%; 7,218 \times .2 = 1,444 SF req'd canopy

1,444 / 707 = 2.0 OR 2 CANOPY TREES; 2 CANOPY TREES PROVIDED.

TREE MITIGATION SEE EXISTING CONDITIONS SHEET

33.6 - 13 = 20.6 MITIGATION TREES REQUIRED. 21 MITIGATION TREES SHOWN

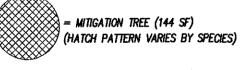

1. ALL PROPOSED VEGETATION WITHIN SIGHT TRIANGLES SHALL NOT INTERFERE WITH CLEAR VISUAL SIGHT LINES FROM 30 INCHES - 10 FT. 2. STREET YARD SHRUBS SHALL BE AT LEAST 3 FEET IN HEIGHT AT TIME OF PLANTING.


3. UNDERSTORY STREET YARD TREES MUST BE 8 - 10 FEET IN HEIGHT AT TIME OF PLANTING.

4. PRIOR TO ANY CLEARING, GRADING OR CONSTRUCTION ACTIVITY, TREE PROTECTION FENCING WILL BE INSTALLED AROUND PROTECTED

TREES OR GROVES OF TREES. 5. ALL LANDSCAPE ISLANDS TO INCLUDE GROUND COVER PLANTINGS. For each open utility cut of City streets, a \$325 permit shall be required from the City prior to occupancy and/or project acceptance.

APPROVED DRAINAGE PLAN Date: <u>08/06/2018</u> Permit #2018033 Signed: *Twill Ballu for RAC*

Approved Construction Plan

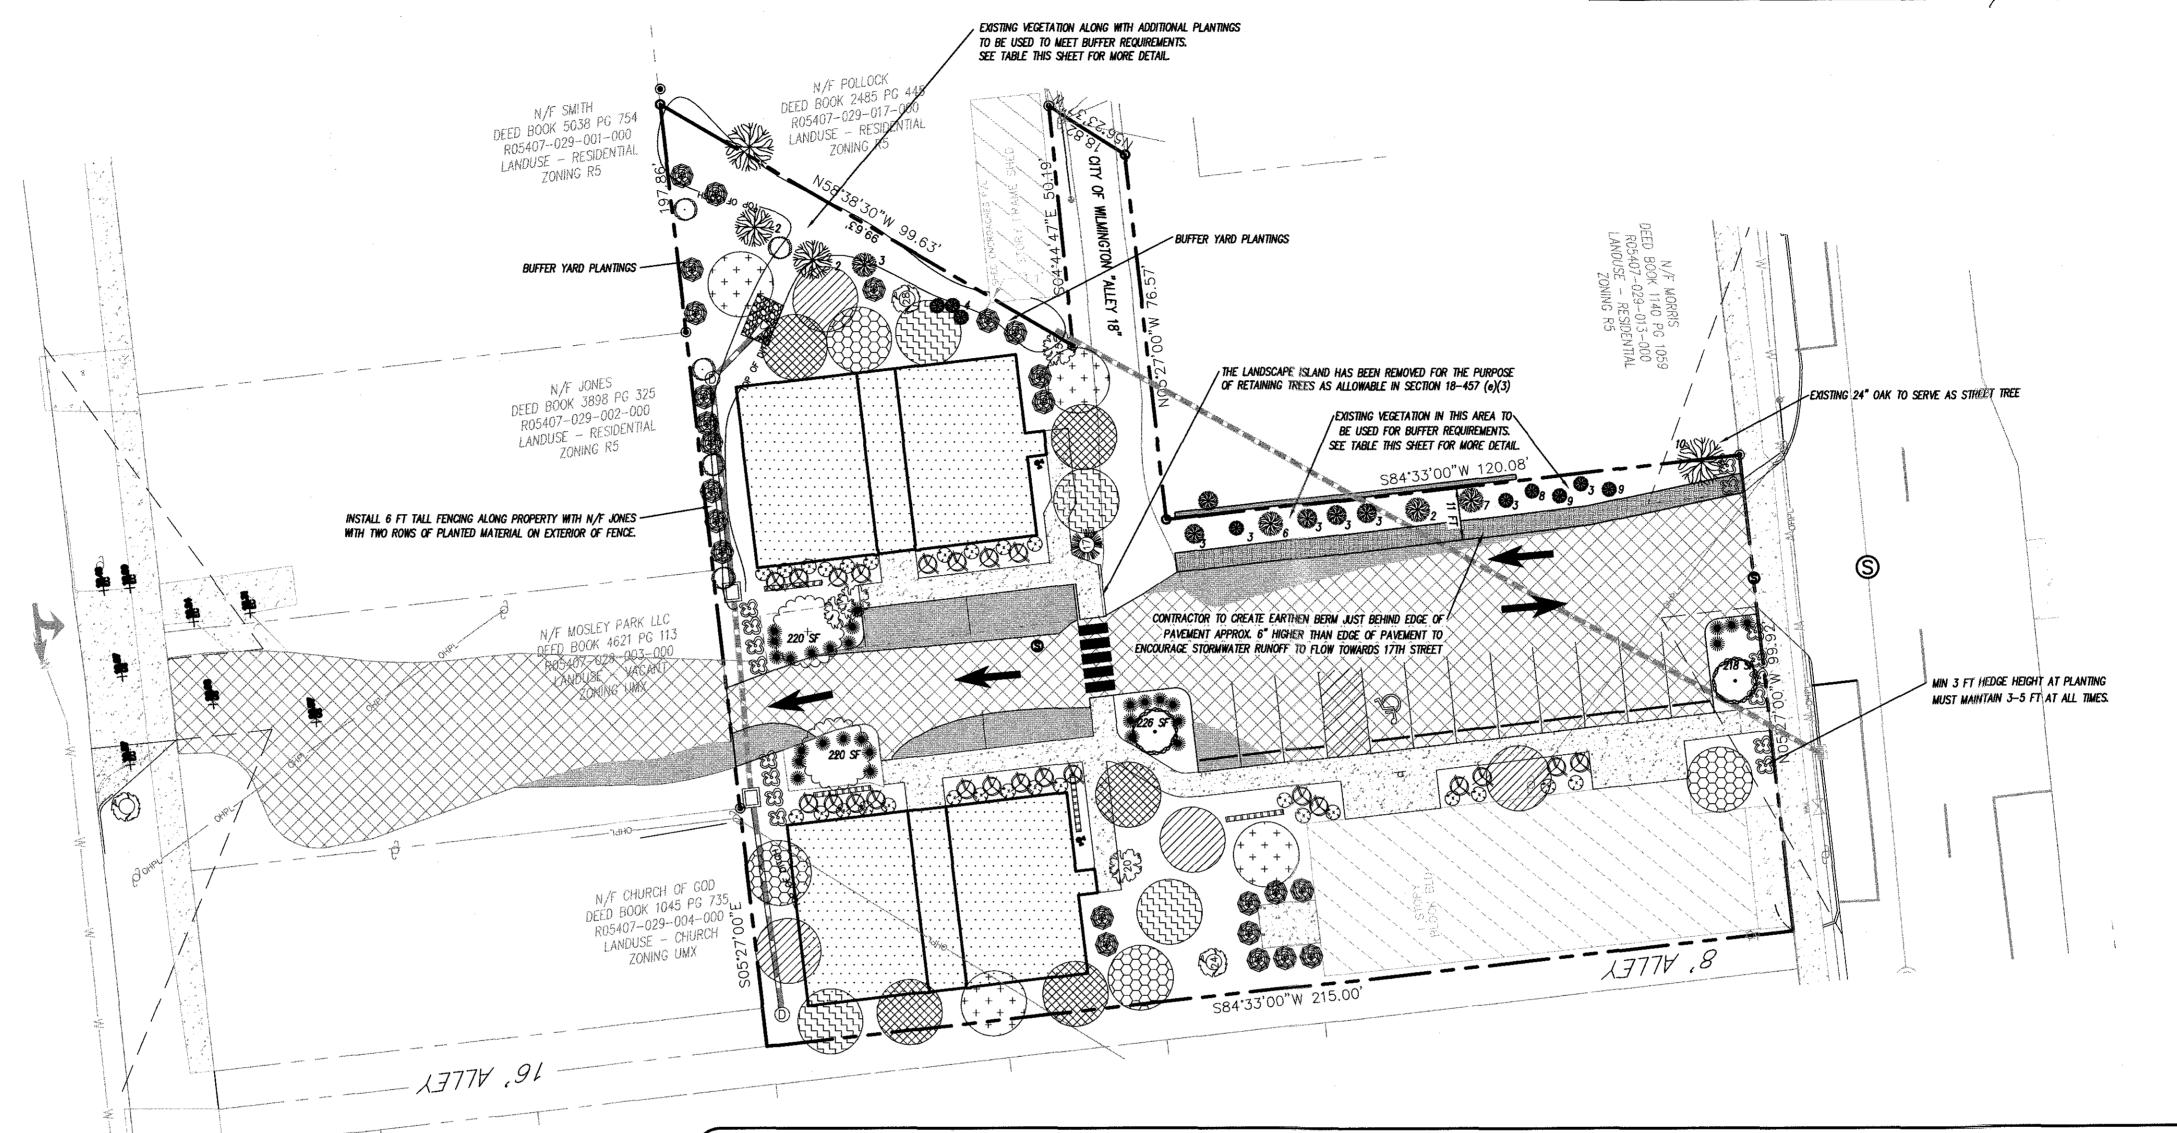

EXISTING BUFFER VEGETATION DESCRIPTION ID # OLEANDER LIGUSTRUM POPLAR SHRUBS PECAN TREE 14" OAK CRAPE MYRTLE PALM 24" LIVE OAK

ENGINEERING BY OWNERS.

FOUNDATION PLANTING SHADE TREES Quantity Symbol Scientific Name NOTE: APPROXIMATE LOCATION AND DESCRIPTION OF EXISTING VEGETATION PROVIDED TO CSD

Proposed Plant Table

Quantity	Symbol	Scientific Name	Common Name	Planting Size	Planting Remarks
16	Œ	llex crenata	STEEDS HOLLY	MIN. 3 FT IN HEIGHT	PARKING AREA SCREENING

INTERIOR PARKING TREE

Quantity	Symbol	Scientific Name	Common Name	Planting Size	Planting Remarks
2	0	Ulmus parvifolia	ALLEE ELM	3" DBH	INTERIOR TREE

Quantity	Symbol	Scientific Name	Common Name	Planting Size	Planting Remarks
23	Ø	llex vomitoria	DWARF YAUPON	3 GAL.	FOUNDATION
30		Muhlenbergia capillaris	PINK MUHLY	3 GAL.	FOUNDATION

quantity	- Jinboi	Solontino Humo	Common Name	1 Torreing Gizes	Fiditury Kernarks
2	+	Quercus virginiana	SOUTHERN LIVE OAK	3" DBH	PARKING SHADING

DUMPSTER CORRAL & HVAC SCREENING								
	Quantity	Symbol	Scientific Name	Common Name	Planting Size	Planting Remarks		
	11		Myrica cerifera	WAX MYRTLE	7 Gal.	SCREENING		

O.C. — "ON CENTER" CAL. — "CALIPER AT 6" ABOVE GRADE" GAL. — "GALLON CONTAINER" STREET YARD SHRUBS SHALL BE AT LEAST 12" HEIGHT AT PLANTING.

MITIGATION TREES

Quantity	Symbol	Scientific Name	Common Name	Planting Size	Planting Remarks
5		Lagerstroemia indica	CRAPE MYRTLE	3" DBH	MITIGATION
4		Carpinus caroliniana	AMERICAN HÖRNBEAM	3" DBH	MITIGATION
4	+ + + + + + + + + + + + + + + + + + + +	Ulmus americana 'Princeton'	PRINCETON ELM	3" DBH	MITIGATION
4		Ulmus propinqua	EMERALD SUNSHINE ELM	3" DBH	MITIGATION
4		Ginkgo biloba (male only)	GINKGO	3" DBH	MITIGATION

BUFFFR YARD

Quantity	Symbol	Scientific Name	Common Name	Planting Size	Planting Remarks
5	0	Nyssa sylvatica	BLACK GUM	3" DBH	BUFFER YARD
13		Myrica cerifera	WAX MYRTLE	7 Gal.	BUFFER YARD

RECEIVED AUG 6 2018 **ENGINEERING**

LICENSE # C-2710 ENGINEERING LAND PLANNING COMMERCIAL / RESIDENTIAL

P.O. BOX 4041 WILMINGTON, NC 28406 (910) 791-4441

LANDSCAPE PLAN STUDIO 17 APARTMENTS



MARS ANR REW REW REW BY WARR

DATE: 3-1-18 HORZ. SCALE: 1" = 20' VERT. SCALE: N/A DRAWN BY: RLW CHECKED BY: HSR PROJECT NO.: 17-0434

Sheet No. LP of LP

